## EXHIBIT 'C'

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SD-2		SITE DEVELOPMENT PLAN
SD-3		LANDSCAPE PLAN
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DP-2		BASEMENT DEMOLTION PLAN
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A-3		ROOF PLAN
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A-6		LARGE SCALE PLANS AND ELEVATIONS
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E-2	<u> </u>	BASEMENT LIGHTING
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E-4		BASEMENT POWER
E-5		SCHEDULES AND RISERS
F-1	<del></del>	FURNISHING PLAN

# MOUNT OLIVE LUTHERAN CHURCH

4018 MINERAL POINT ROAD MADISON, WI 53705

### POTTER DESIGN GROUP, INC./S.M.S.Q.

ARCHITECTS \* PLANNERS \* BUILDING CONSULTANTS 735 JENIFER STREET MADISON, WISCONSIN 53703 (608) 257-3825



POTTER DESIGH GROUP 735 JEHHIFER ST. MADISON, WI.

ESIGN GROUP / S.M.S.

ANNERS \* BUILDING CONSULTANTS

SET S3703

ARCHITECTS \* PLANNERS \* B
735 JENIFER STREET
MADISON, WISCONSIN 53703
(608) 257-3825

ELING FOR:
ERAN CHURCH

LIVE LUT旧国

MOUNT

10/7/92

REVISIONS


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PDG JOB NO.

9029

SHEET NO.

SD-

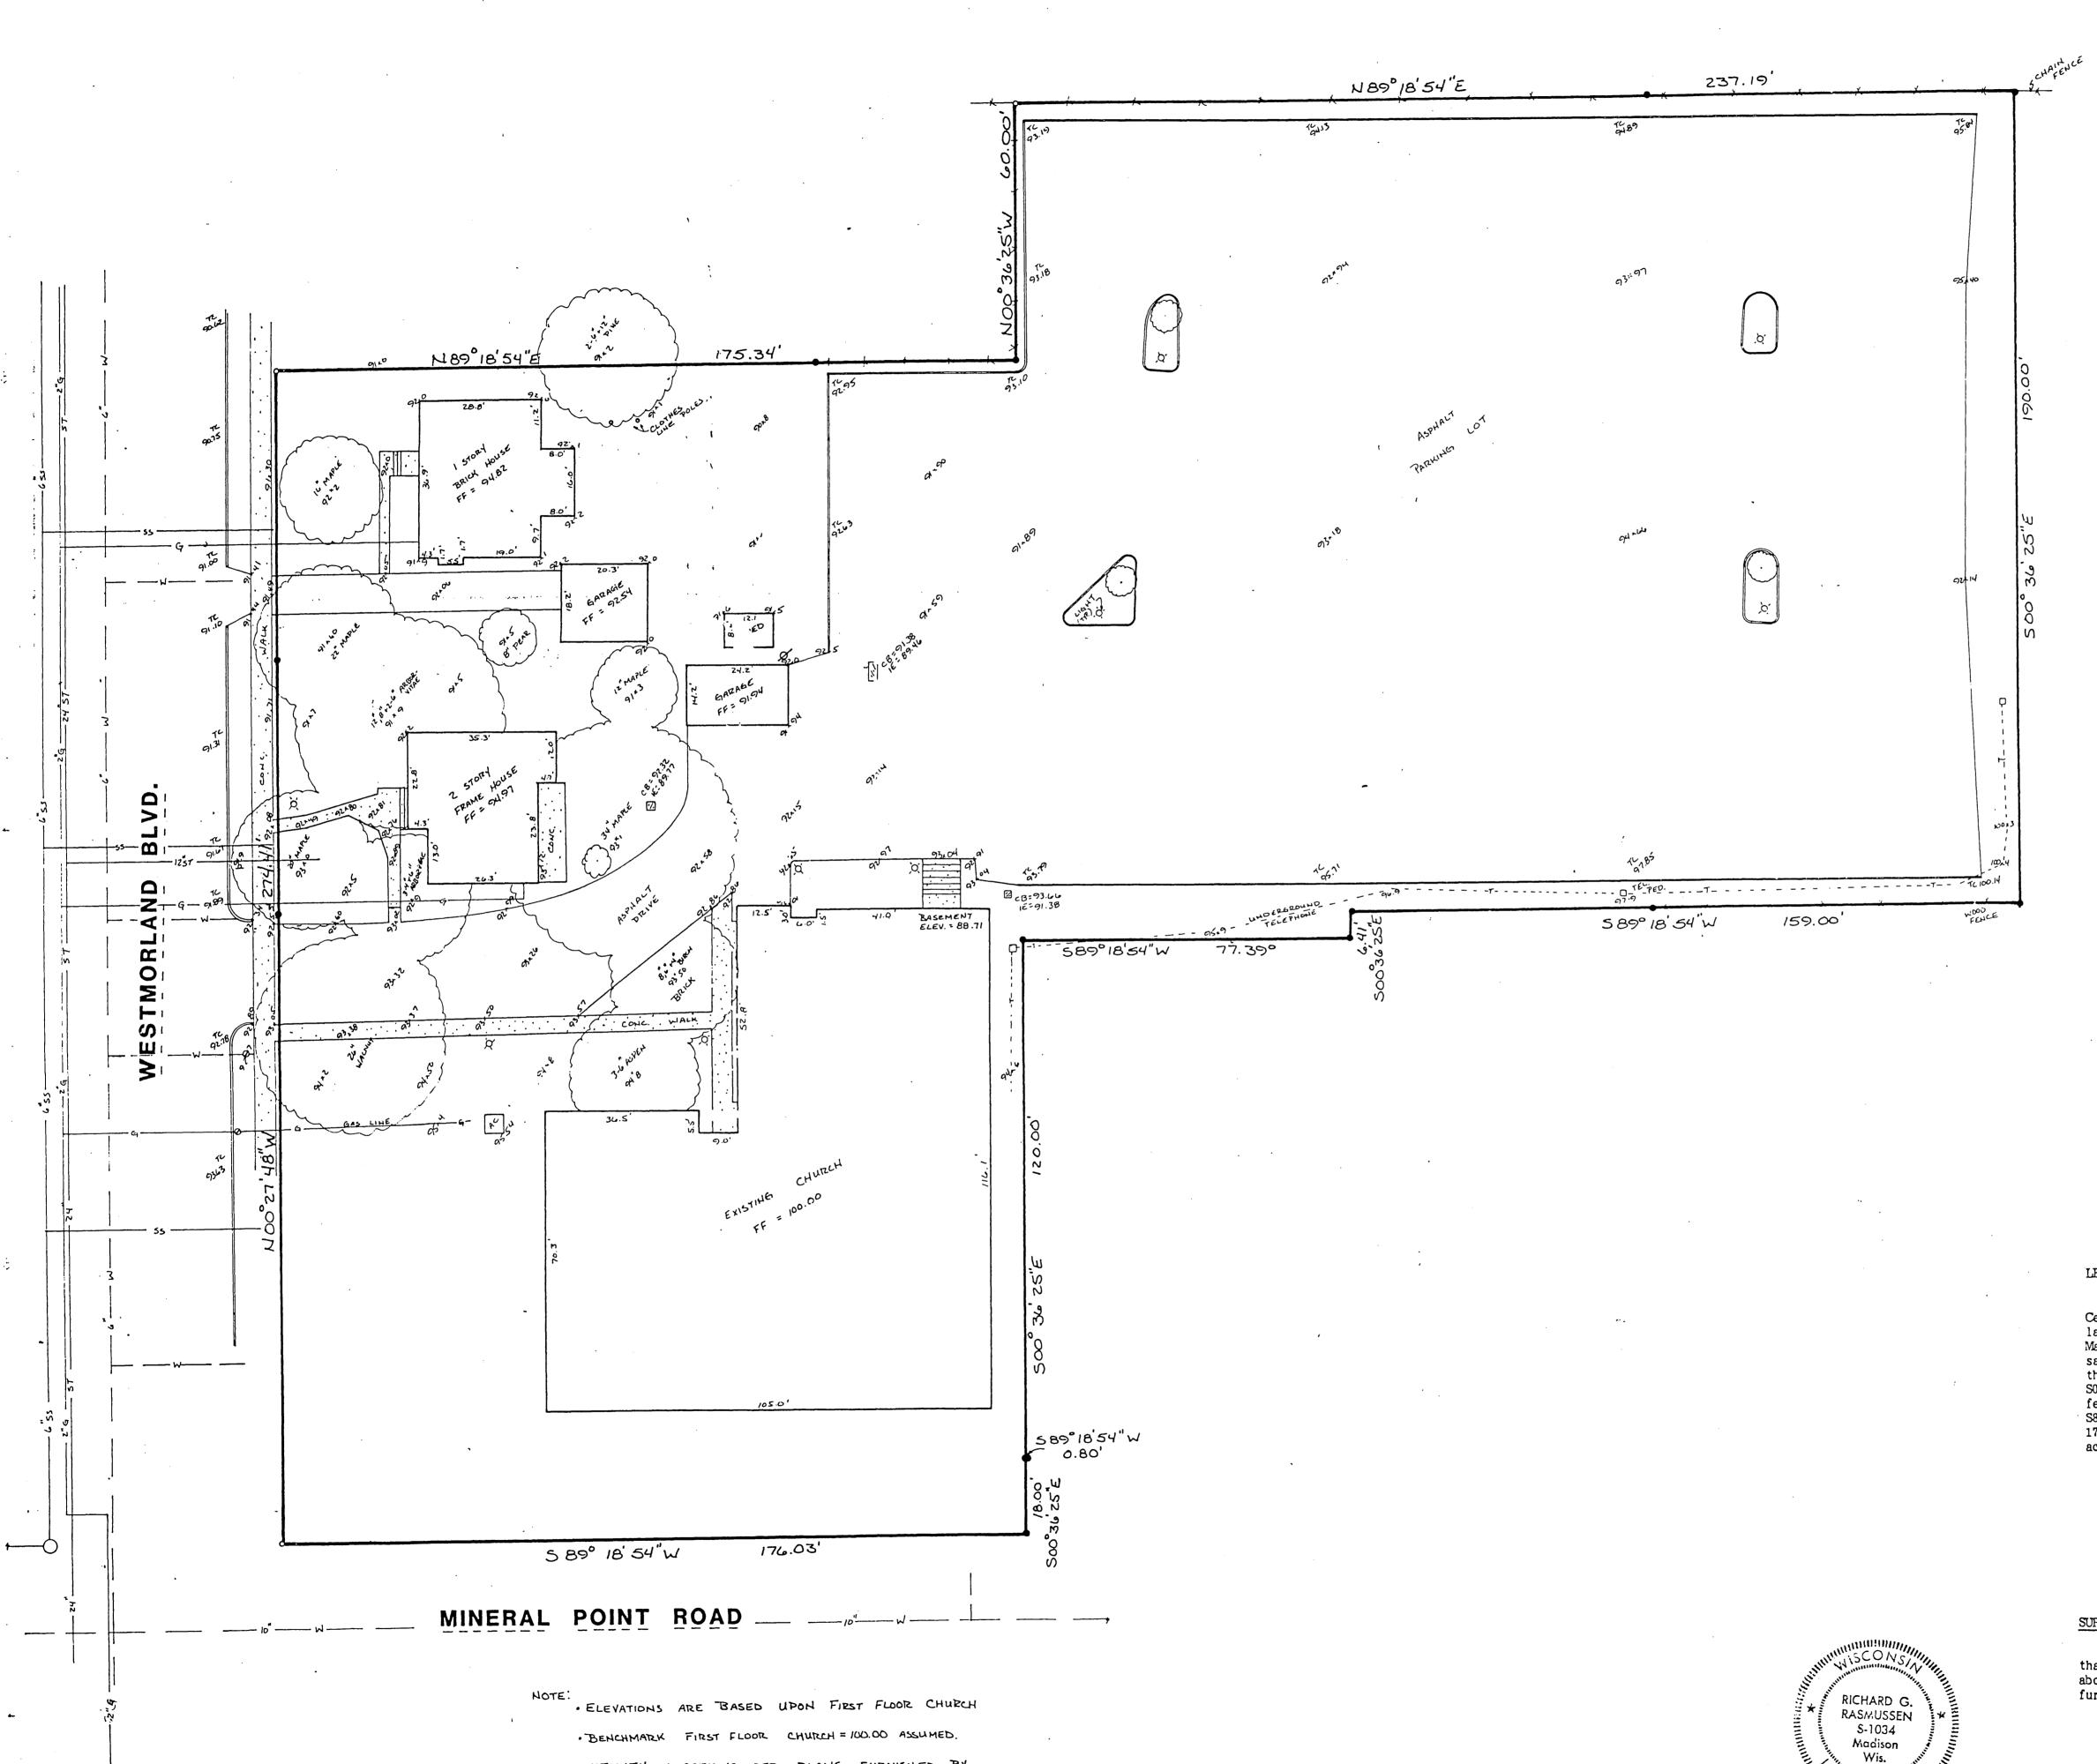

· UTILITY LOCATIONS PER PLANS FURNISHED BY CITY OF MADISON AND MGCE. NOT FIELD LOCATED.

#### LEGAL DESCRIPTION:

Lots 1 and 2 Certified Survey Map No. 2698 recorded in Volume 10 of Certified Survey Maps Pages 358 and 359 Dane County Registry and 2 parcels of land all located in the SW 1/4 of the SW 1/4 of Section 21, T7N, R9E, City of Madison, Dane County, Wisconsin, To-wit: Beginning at the southwest corner of said Lot 1; thence N00°27'48'W, 274.41 feet; thence N89°18'54"E, 175.34 feet; thence N00°36'25"W, 60.00 feet; thence N89°18'54"E, 237.19 feet; thence S00°36'25"E, 190.00 feet; thence S89°18'54"W, 159.00 feet; S00°36'25"E, 6.41 feet; thence S89°18'54"W, 77.39 feet; thence S00°36'25"E, 120.00 feet; thence S89°18'54"W, 0.80 feet; thence S00°36'25"E, 18.00 feet; thence S89°18'54"W, 176.03 feet to the point of beginning. Containing 93,873 square feet (2.155 acres).

#### SURVEYOR'S CERTIFICATE:

I, Richard G. Rasmussen, Registered Land Surveyor, S-1034, hereby certify that I have made a survey of the above described parcel and that the map drawn above is a correct representation of that survey according to the information furnished to me.

Dated this /3 day of JULY , 199

Richard G. Rasmussen, S-1034

10/7/92

REVISIONS

PDG JOB NO.

9029

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AND

ADDITION

REVISIONS

PDG JOB NO.

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### GENERAL NOTES

L ALL DIMENSIONS ARE TO FACE OF FINISH MATERIAL UNLESS NOICATED OTHERWISE

2. RECONSTRUCT ALL CONSTRUCTION DAMAGED DURING CONSTRUCTION PROCESS SO AS TO MATCH ORIGINAL CONDITION OR ADJACENT SURFACES AND MATERIAL.

3. DIMENSIONS FOLLOWED BY E' NOICATE EXISTING DIMENSIONS TO BE VARIFED IN FIELD

4. DISCARD ALL CONSTRUCTION TO BE REMOVED UNLESS NOTED OTHERWISE

5. SEE ARCHITECTURAL PLAN FOR EXACT LOCATION OF PROPOSED ADDITION AND REMOVATION WORK, SHOWN FOR REFERENCE ONLY ON THIS SHEET.

6. PROTECT ALL CONSTRUCTION TO REMAIN

7. ALL PAVING AND CONCRETE CONSTRUCTION TO BE REMOVED, BOTH EXTERIOR AND INTERIOR, SHALL BE SAW CUT.

8. REMOVE CROSS AS PART OF ALT. #7, REMOVE ROOF CONSTRUCTION AS REQUIRED FOR WINDOW AS PART OF ALTERNATE #7, REQUIRED TO FURNISH AND INSTALL NEW STARR AS DETAILED

9. REMOVE PLATFORMS AND STONE WALLS AND PARTITIONS AS PART OF ALTERNATE #7

10. REMOVE ENTRY MAT

11. REMOVE CONCRETE TOPPING AT LANDING

12. SALVAGE DOORS TO BE REMOVED FOR RE-USE AND/OR TURN OVER TO OWNER

13. SALVAGE CABINET HEATER AND TURN OVER TO OWNER FOR PARTS

14. REMOVE TAR AND GRAVEL/BUILT OF ROOFING THIS AREA DOWN TO RIGID NSILLATION FOR NEW ROOF INSILATION AND ROOFING MEMBRANE

15. REMOVE GRAVEL STOP AND ASSOCIATED CONSTRUCTION

16. TURN OVER TO OWNER ALL STONE TO BE REMOVED SHALL REMAIN 16. REMOVE SECTION OF ROOF AND RELOCATE OPEN WEB STIEL JOISTS

16. TURN OVER TO OWNER ALL STONE TO BE REMOVED SHALL REMAIN 16. REMOVE SECTION OF ROOF AND RELOCATE OPEN WEB STIEL JOISTS

17. DECOMODATE SKYLIGHTS (TOTAL OF 3) AS PART OF ALTERNATE #5

19. REMOVE WALL SECTION AND DOORS AND STIEL CROSS BEAM (1 OF 2 LOCATIONS ONLY) AS PART OF ALTERNATE #7

EXISTING CONSTRUCTION TO BE REMOVED

EXISTING CONSTRUCTION TO BE REMOVED AS PART OF ALTERNATES AS SPECIFIED

LEGEND

WOOD FRAME CONSTRUCTION CMU CONSTRUCTION

Q .M.S.

S GROUP DESIGN ARCHITECTS \* PLANN 735 JENIFER STREET MADISON, WISCONSIN (608) 257-3825 POTTER

CHURCH REMODELING ADDITION MOUNT

10/7/92

REVISIONS

PDG JOB NO 9029

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L ALL DIMENSIONS ARE TO FACE OF FINISH MATERIAL UNLESS NDICATED OTHERWISE

2. RECONSTRUCT ALL CONSTRUCTION DAMAGED DURING CONSTRUCT PROCESS SO AS TO MATCH ORIGINAL CONDITION OR ADJACENT SURFACES AND MATERIAL

3. DIMENSIONS FOULDWED BY "E" INDICATE EXISTING DIMENSIONS TO BE VARIFED IN FIELD.

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5. SEE ARCHITECTURAL PLAN FOR EXACT LOCATION OF PROPOSEL ADDITION AND RENOVATION WORK, SHOWN FOR REFERENCE ONLY ON THIS SHEET.

6. PROTECT ALL CONSTRUCTION TO REMAIN

7. ALL PAVING AND CONCRETE CONSTRUCTION TO BE REMOVED, BOTH EXTERIOR AND INTERIOR, SHALL BE SAW CUT.

8. REMOVE SECTIONS OF EXISTING FOOTING AND ASSOCIATED CONSTRUCTION AS REQUIRED FOR BEVATOR PIT AND SLAB

9. SALVAGE ALL DOORS TO BE REMOVED FOR RE-USE OR TURN OVER TO OWNER

WOOD FRAME CONSTRUCTION

CMU CONSTRUCTION

NG FOR:

CHURCH

DESIGN

POTTER

DDITION AND REMODELING FOR THE REMODELING FOR THE REMODELING REMODELING FOR THE REMODELIN

MOUNT


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PDG JOB NO.

SHEET NO.

DP-2



CHURCH REMODELING UTRIER ADDITION A MOUNT

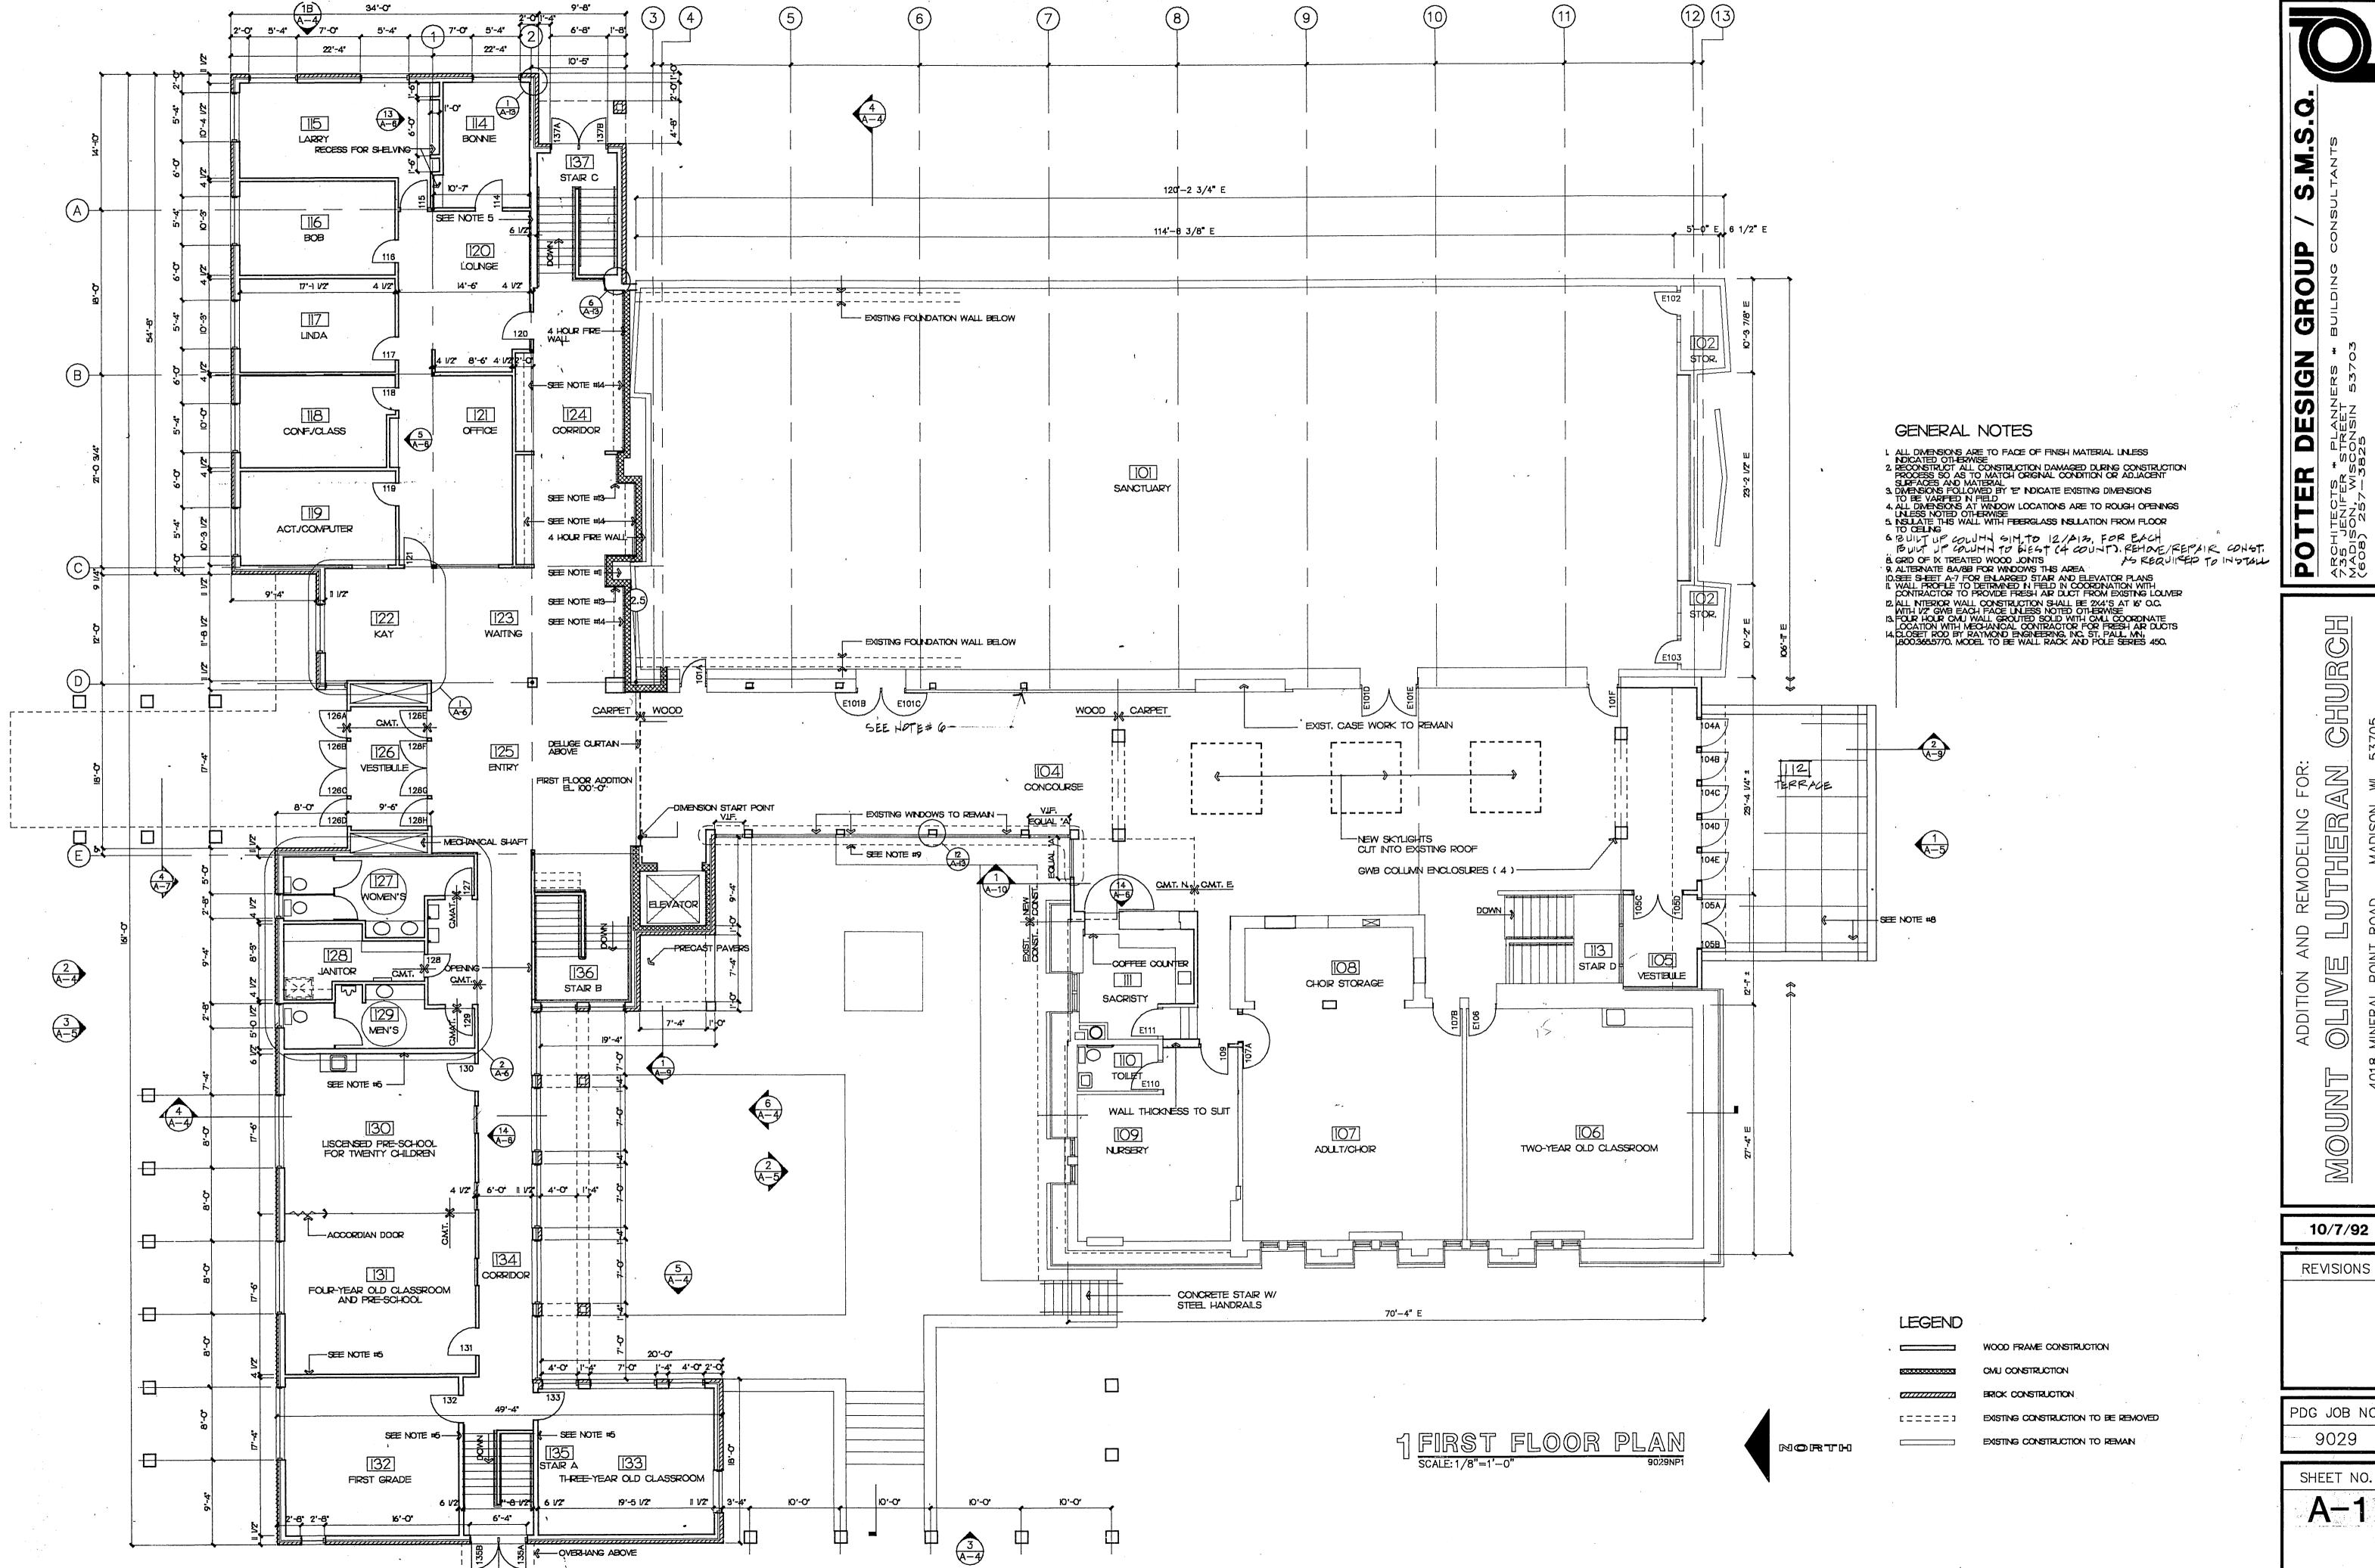
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SHEET NO.

A-1



GROUP

DESIGN

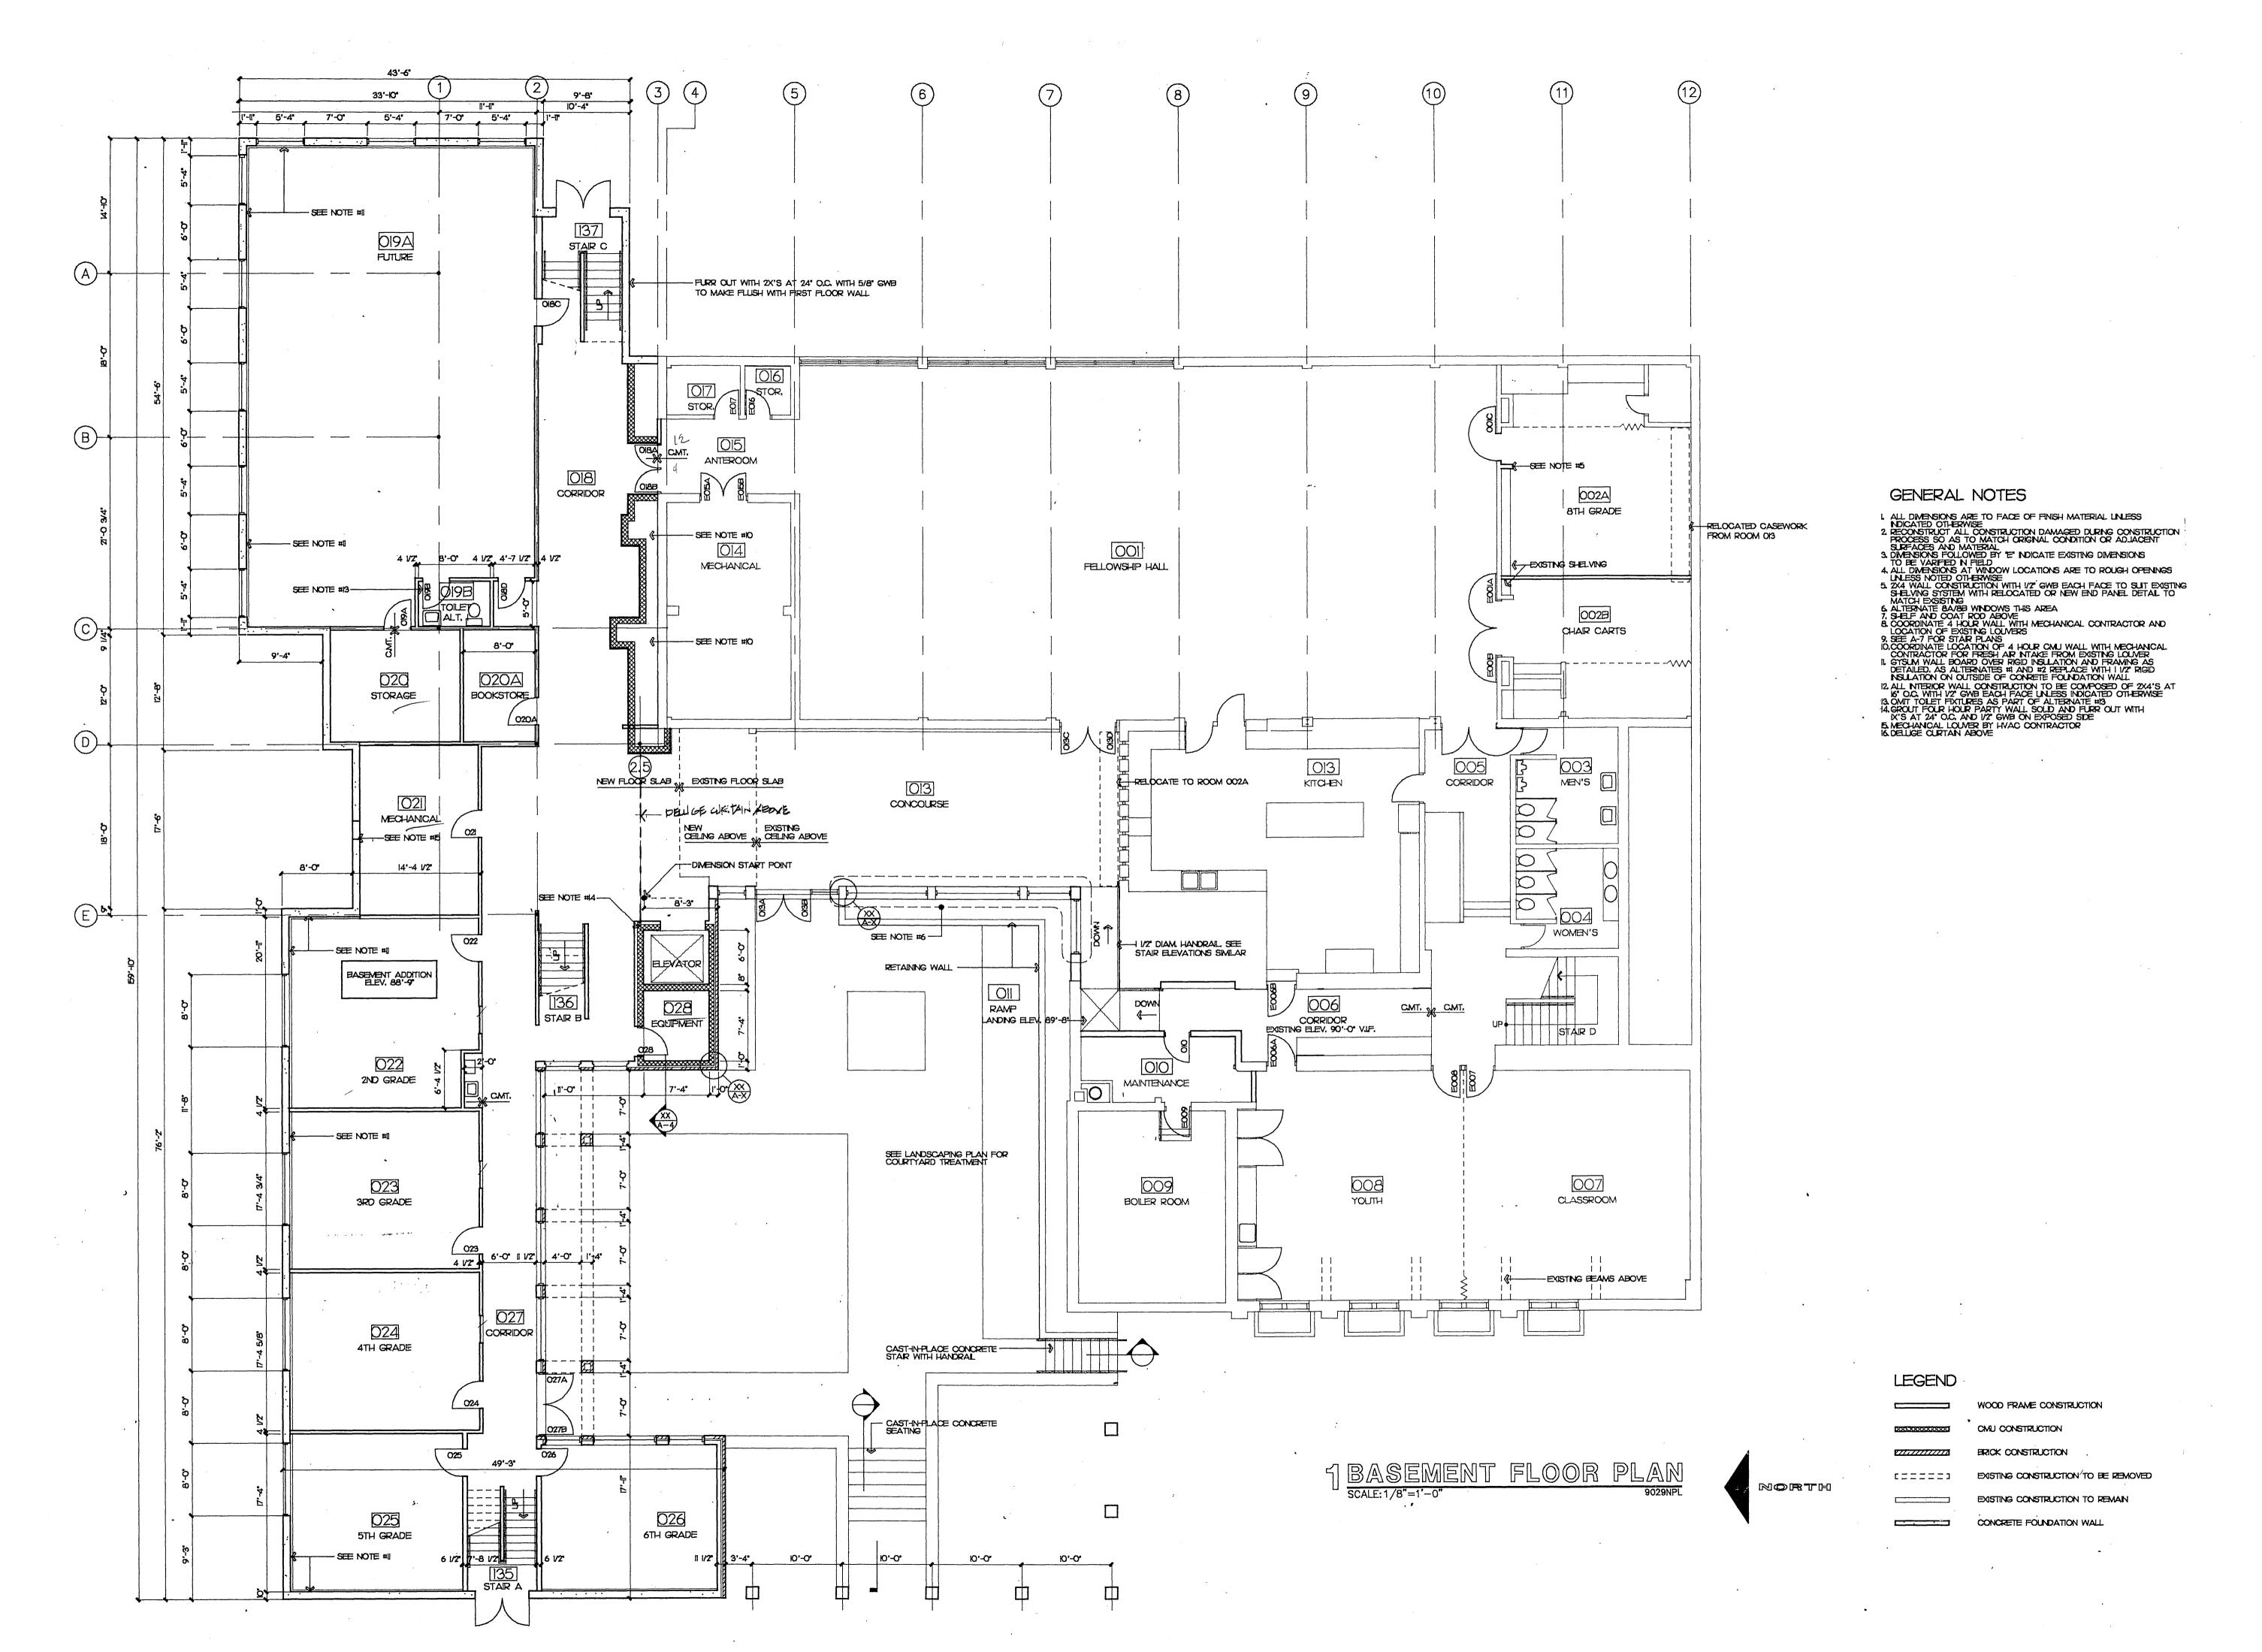
POTTER \*
ARCHITECTS \*
735 JENIFER S
MADISON, WISC
(608) 257-38

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10/7/92

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PDG JOB NO. 9029



GROUP SIGN ARCHITECTS \* PLANNE 735 JENIFER STREET MADISON, WISCONSIN 5 (608) 257-3825

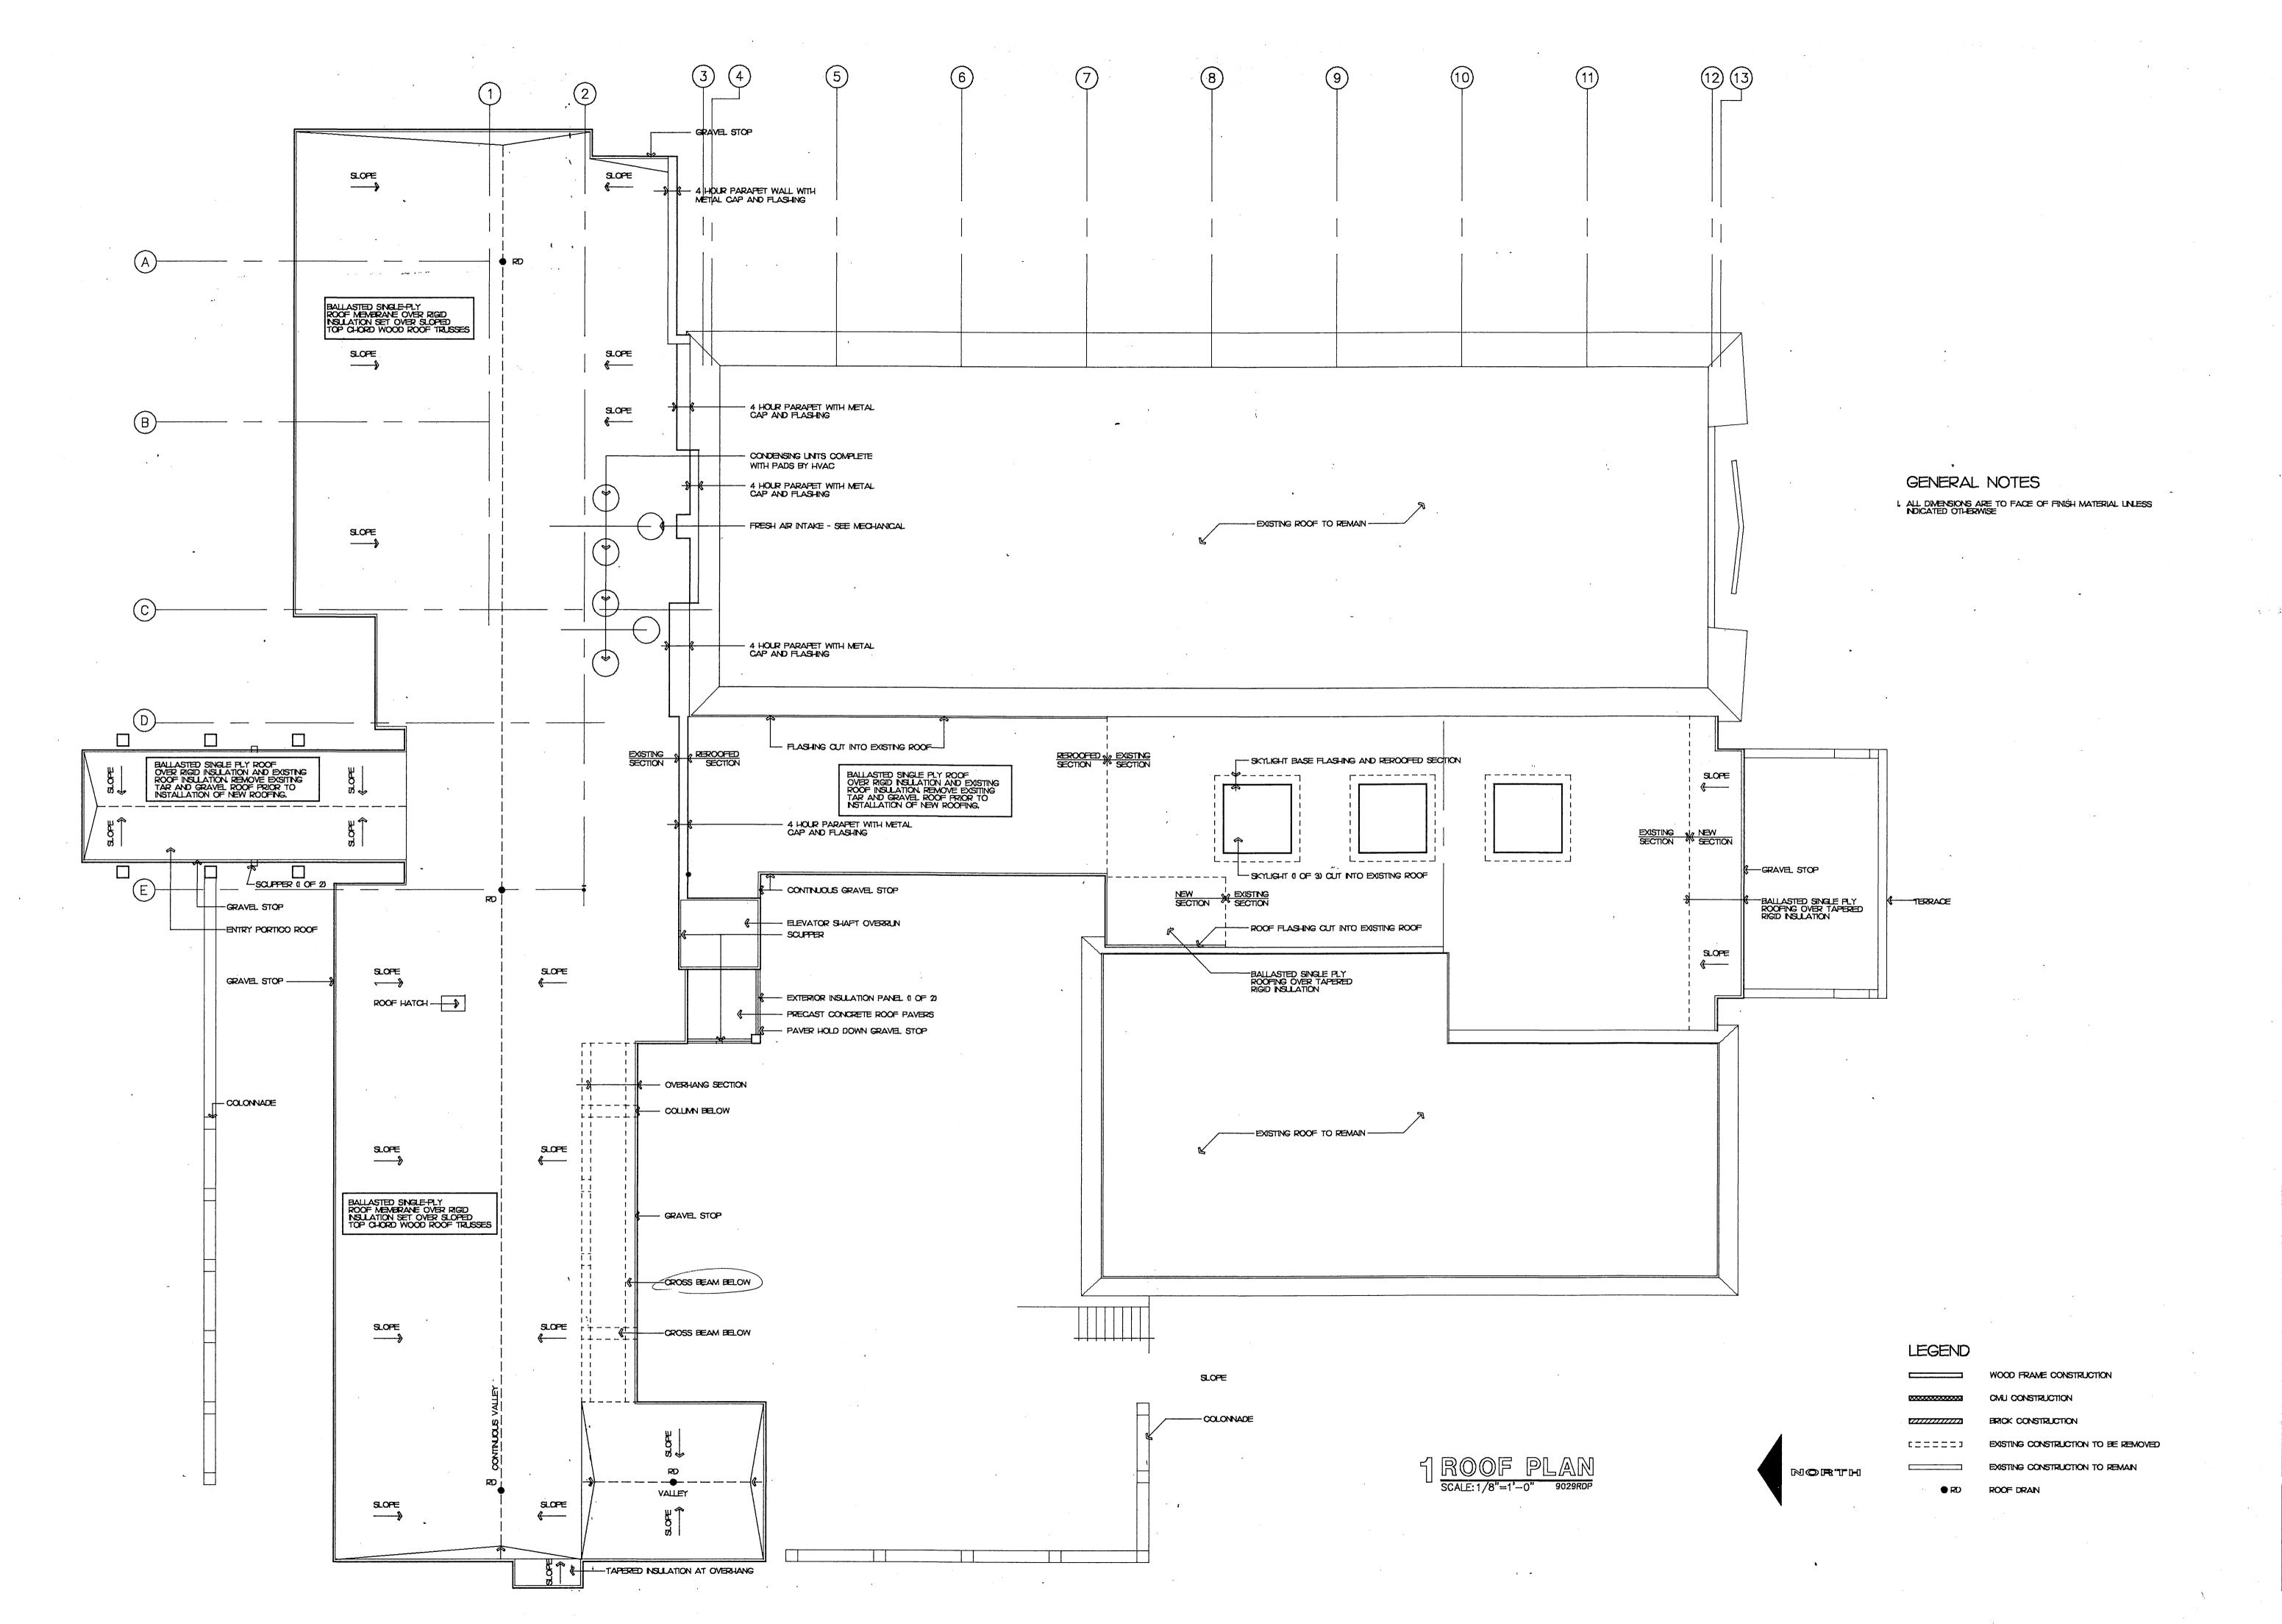
CHURCH AND ADDITION MOUNT


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SHEET NO. A-3





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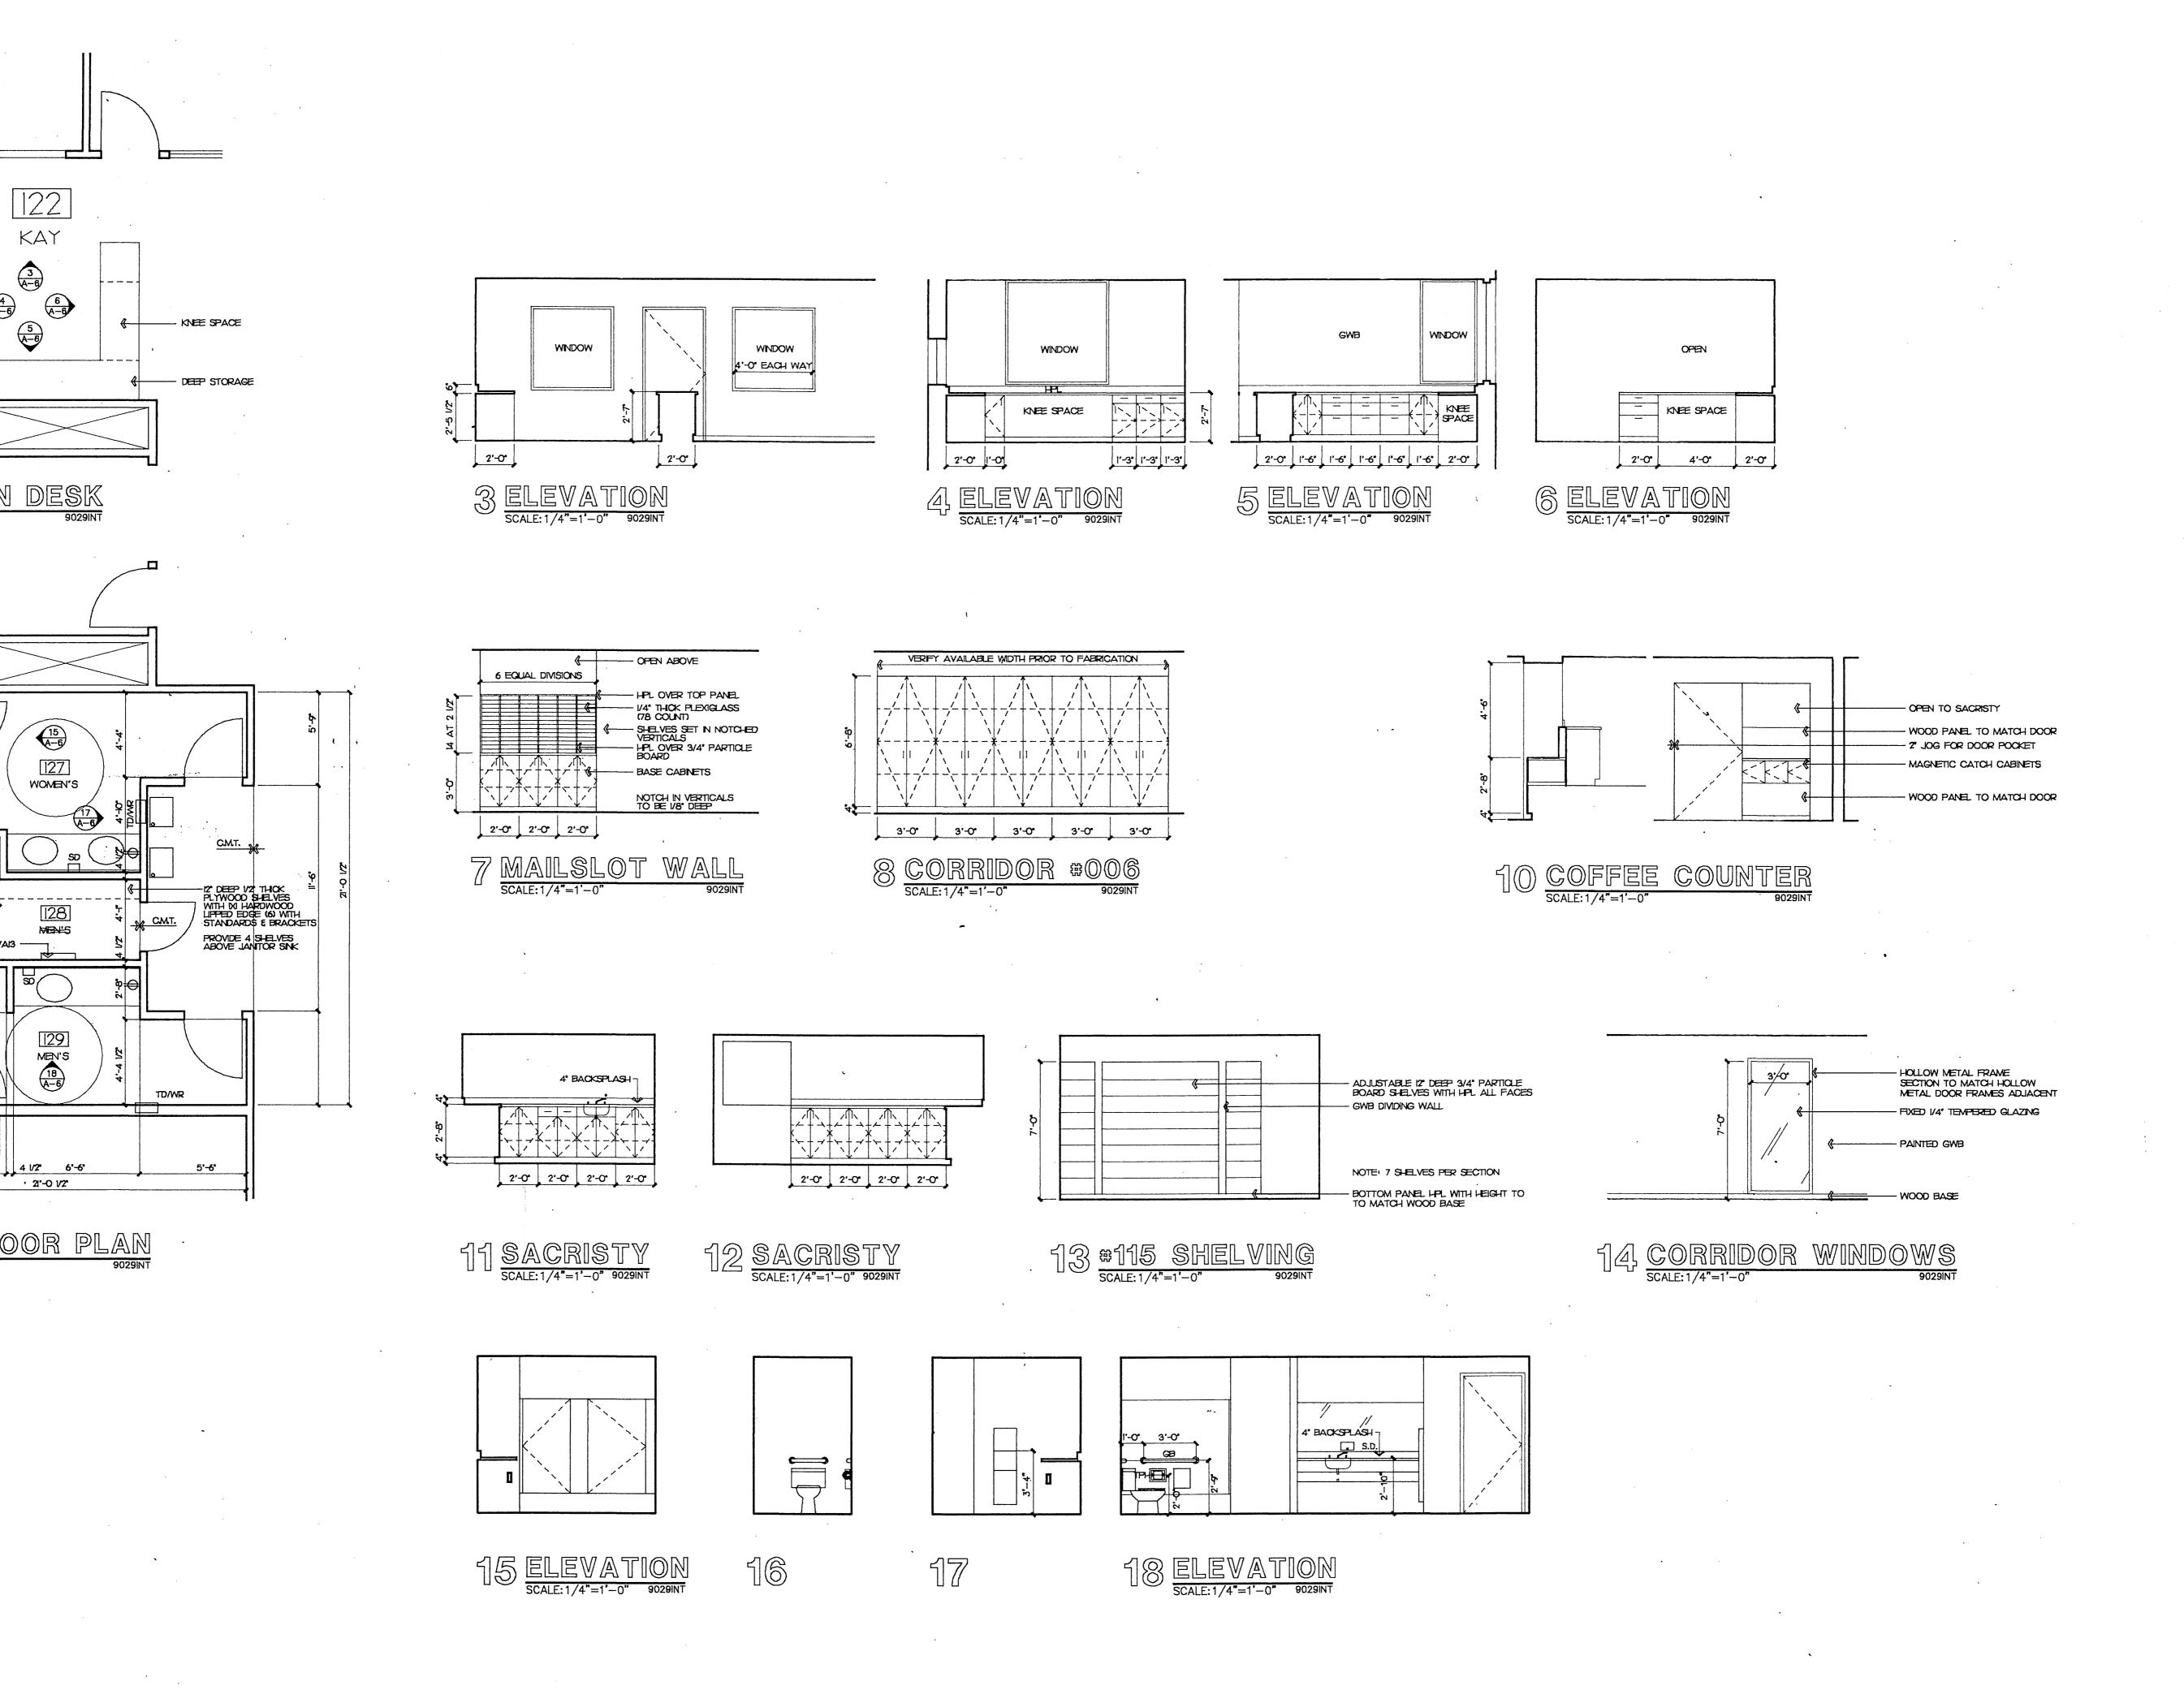
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PDG JOB NO

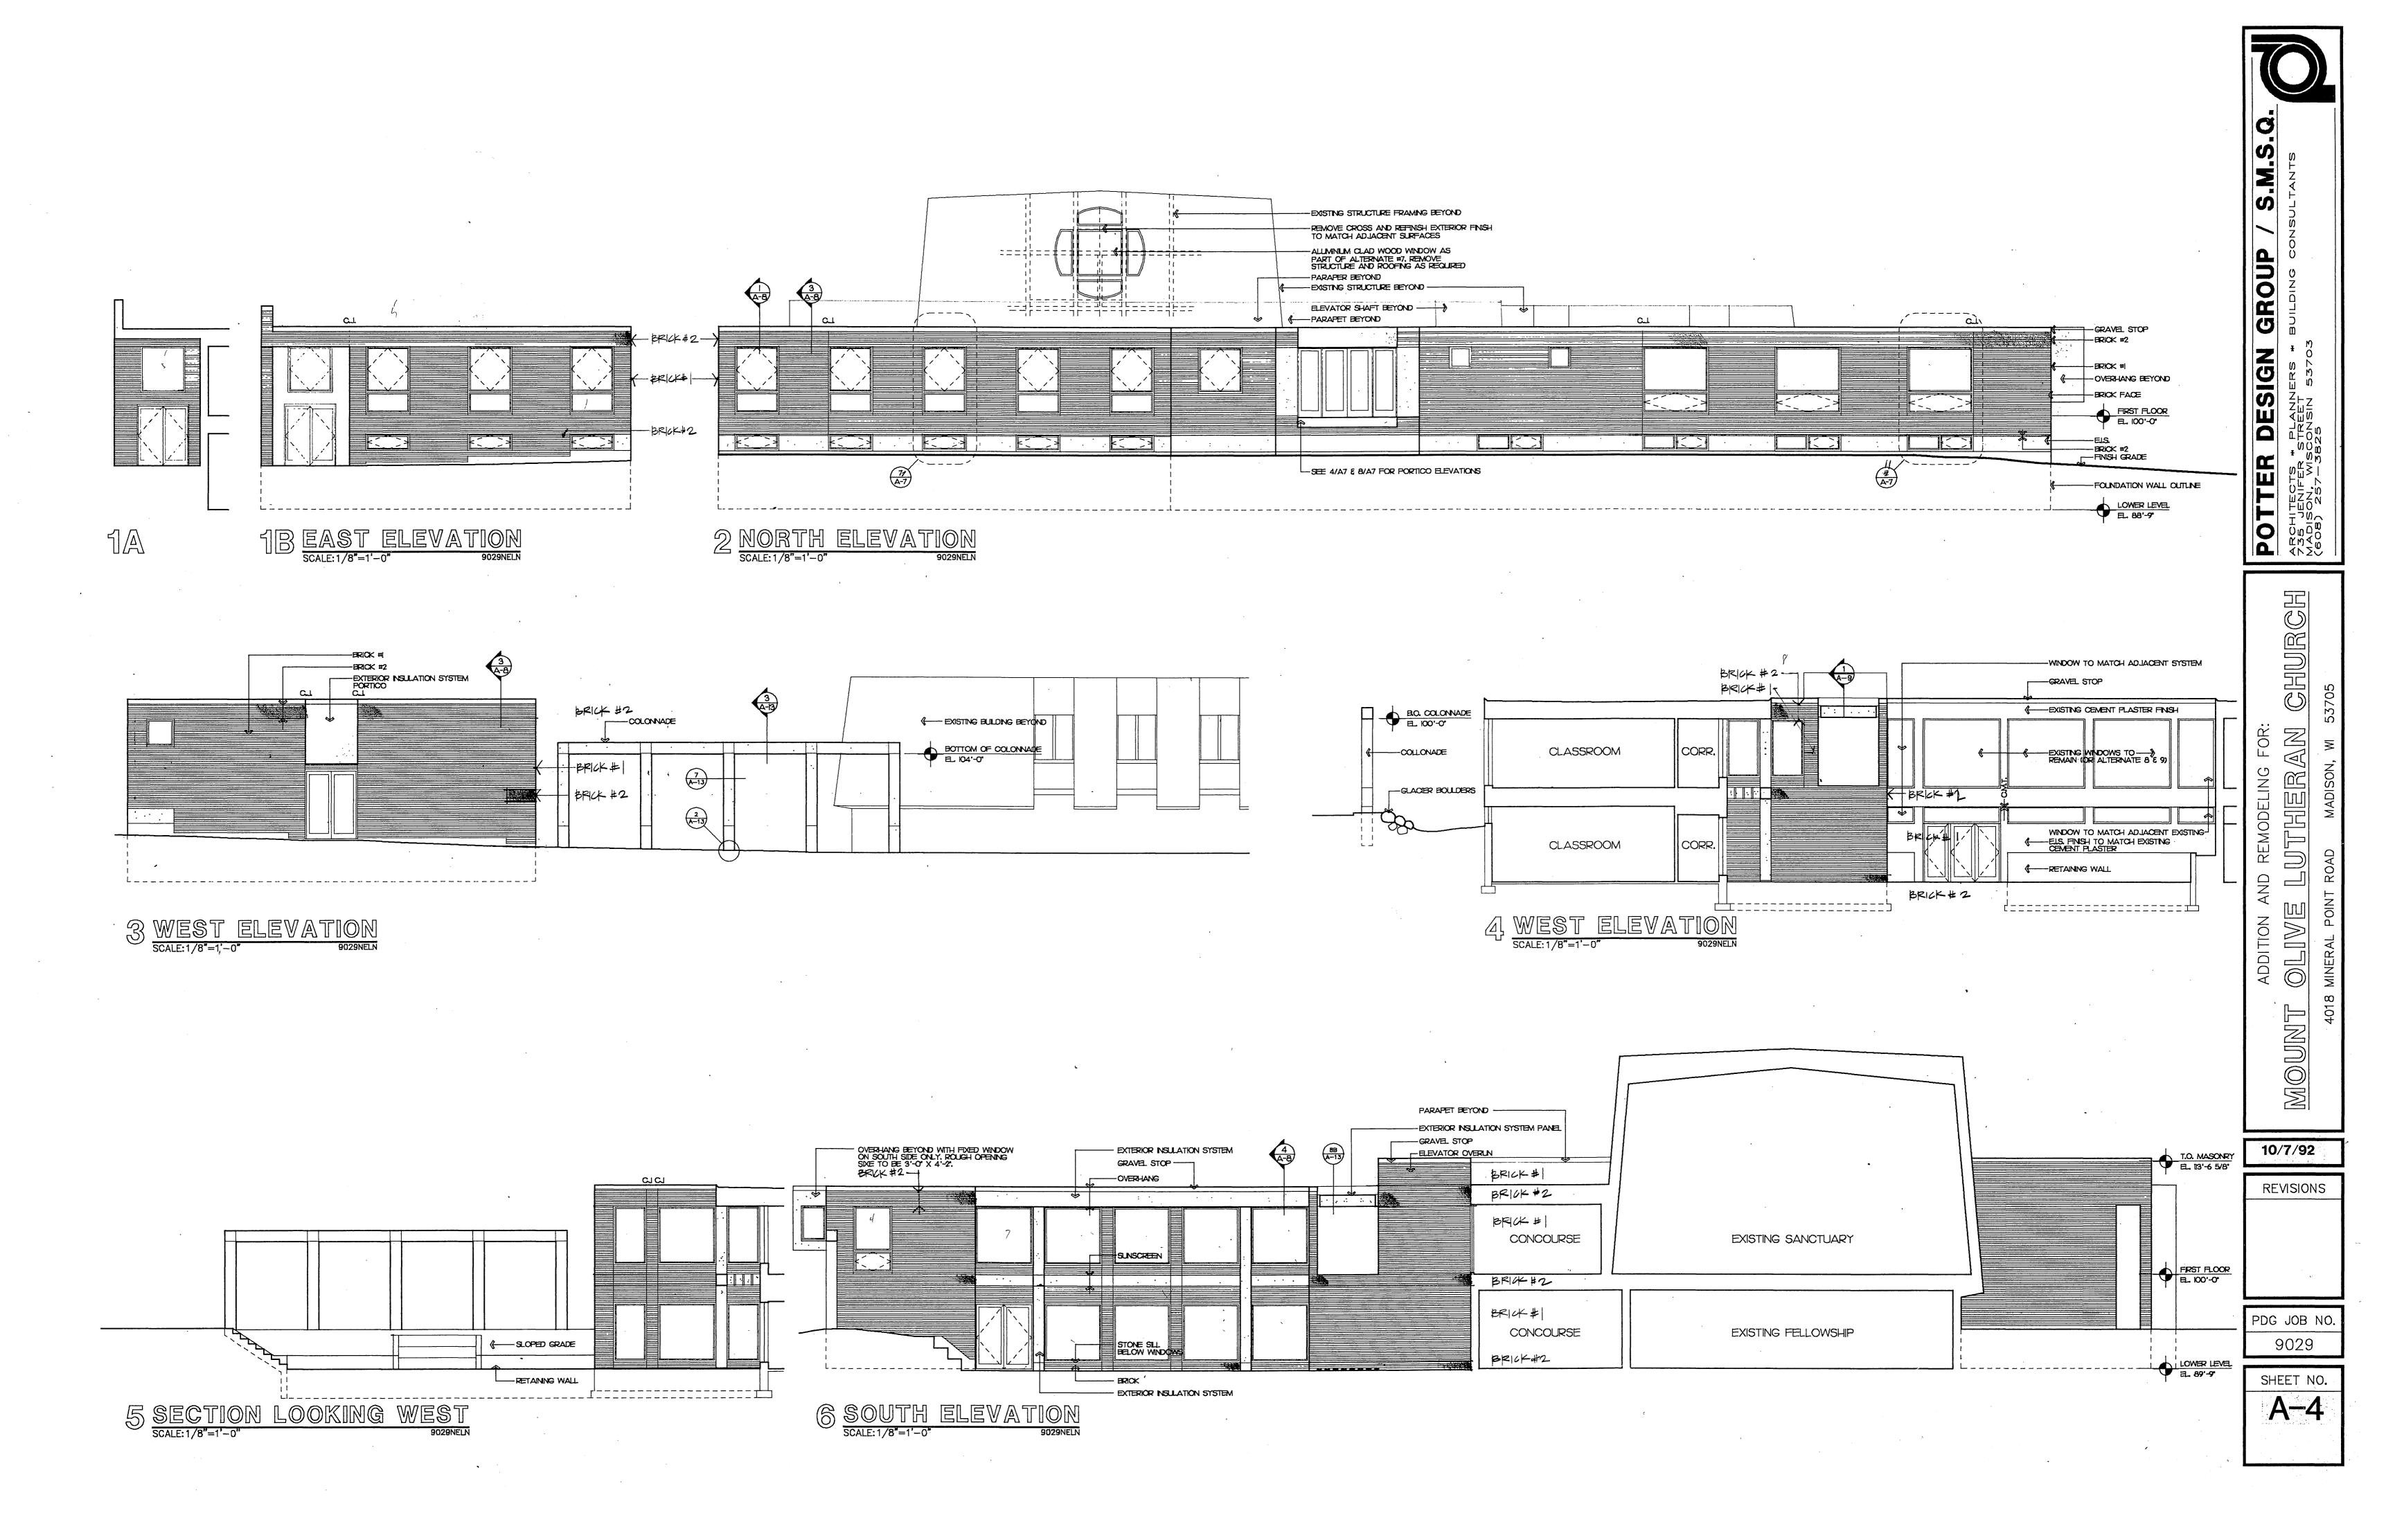9029

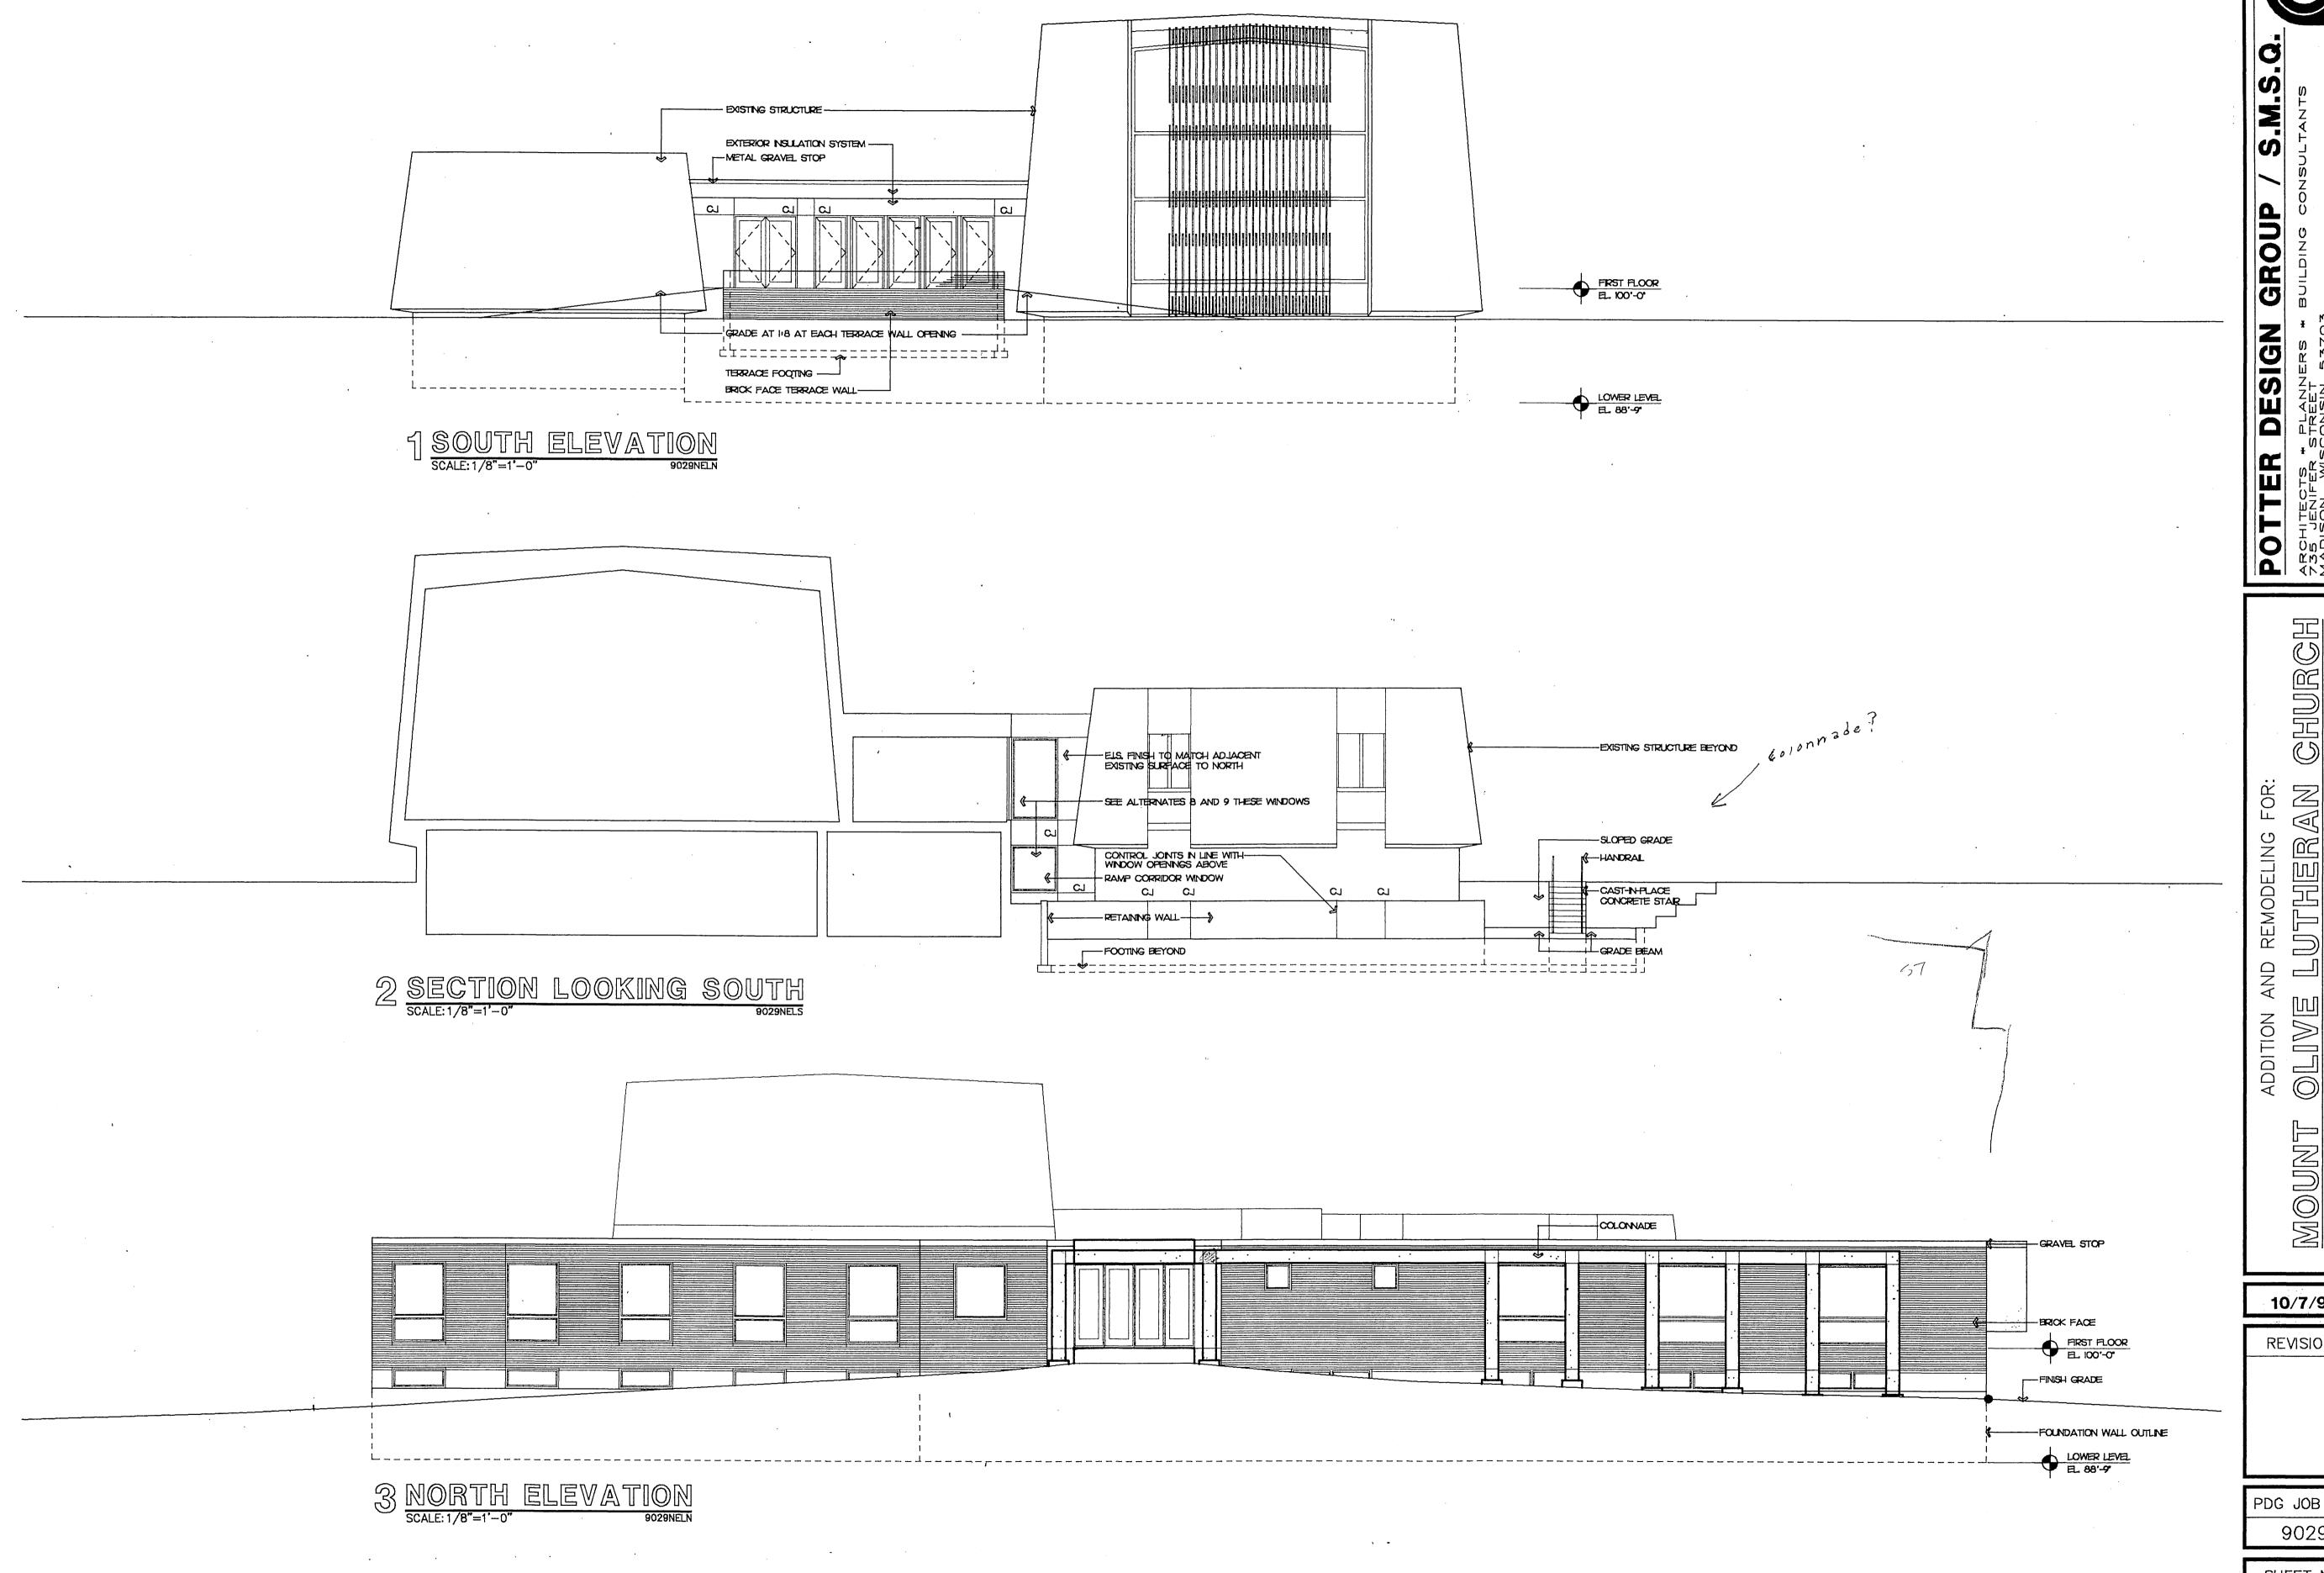SHEET NO.

A-6



4 A-6

KNEE SPACE -

DEEP STORAGE-


SCREEN, TYPICAL-


FUTURE JANTOR SINK


SCALE: 1/4"=1'-0"


ROOF ACCESS LADDER SEE 5/A/3


3'-0"

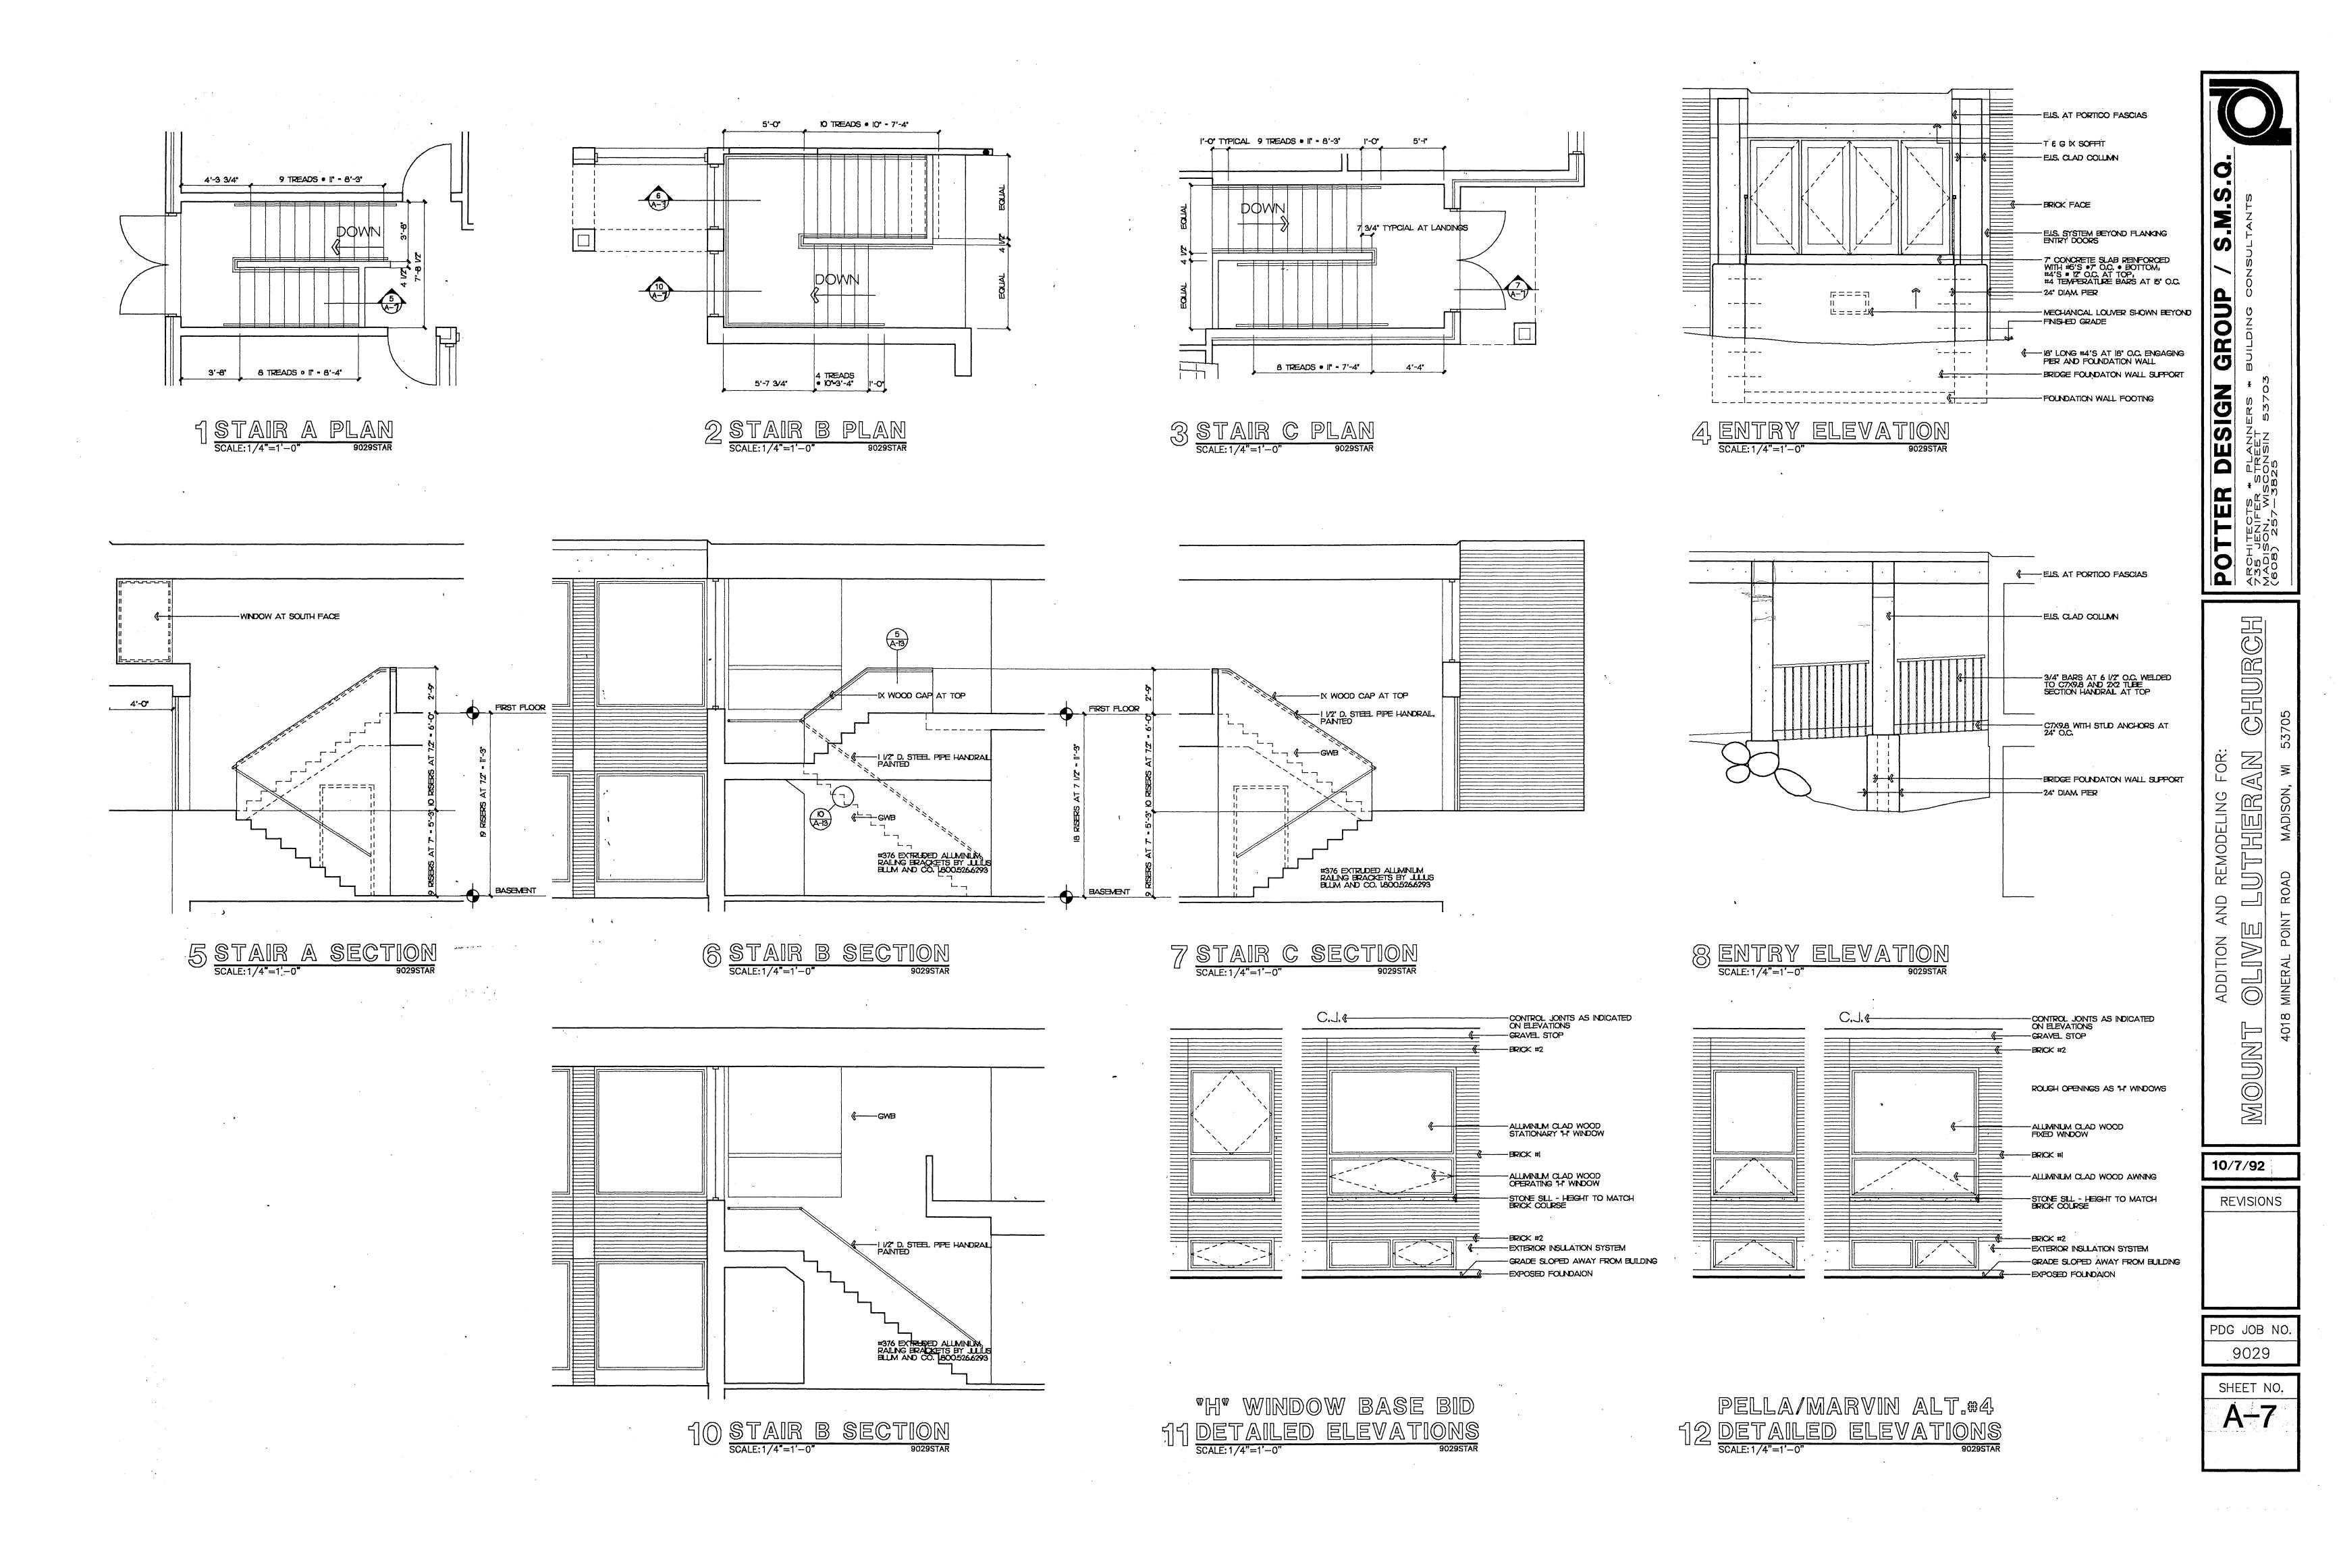

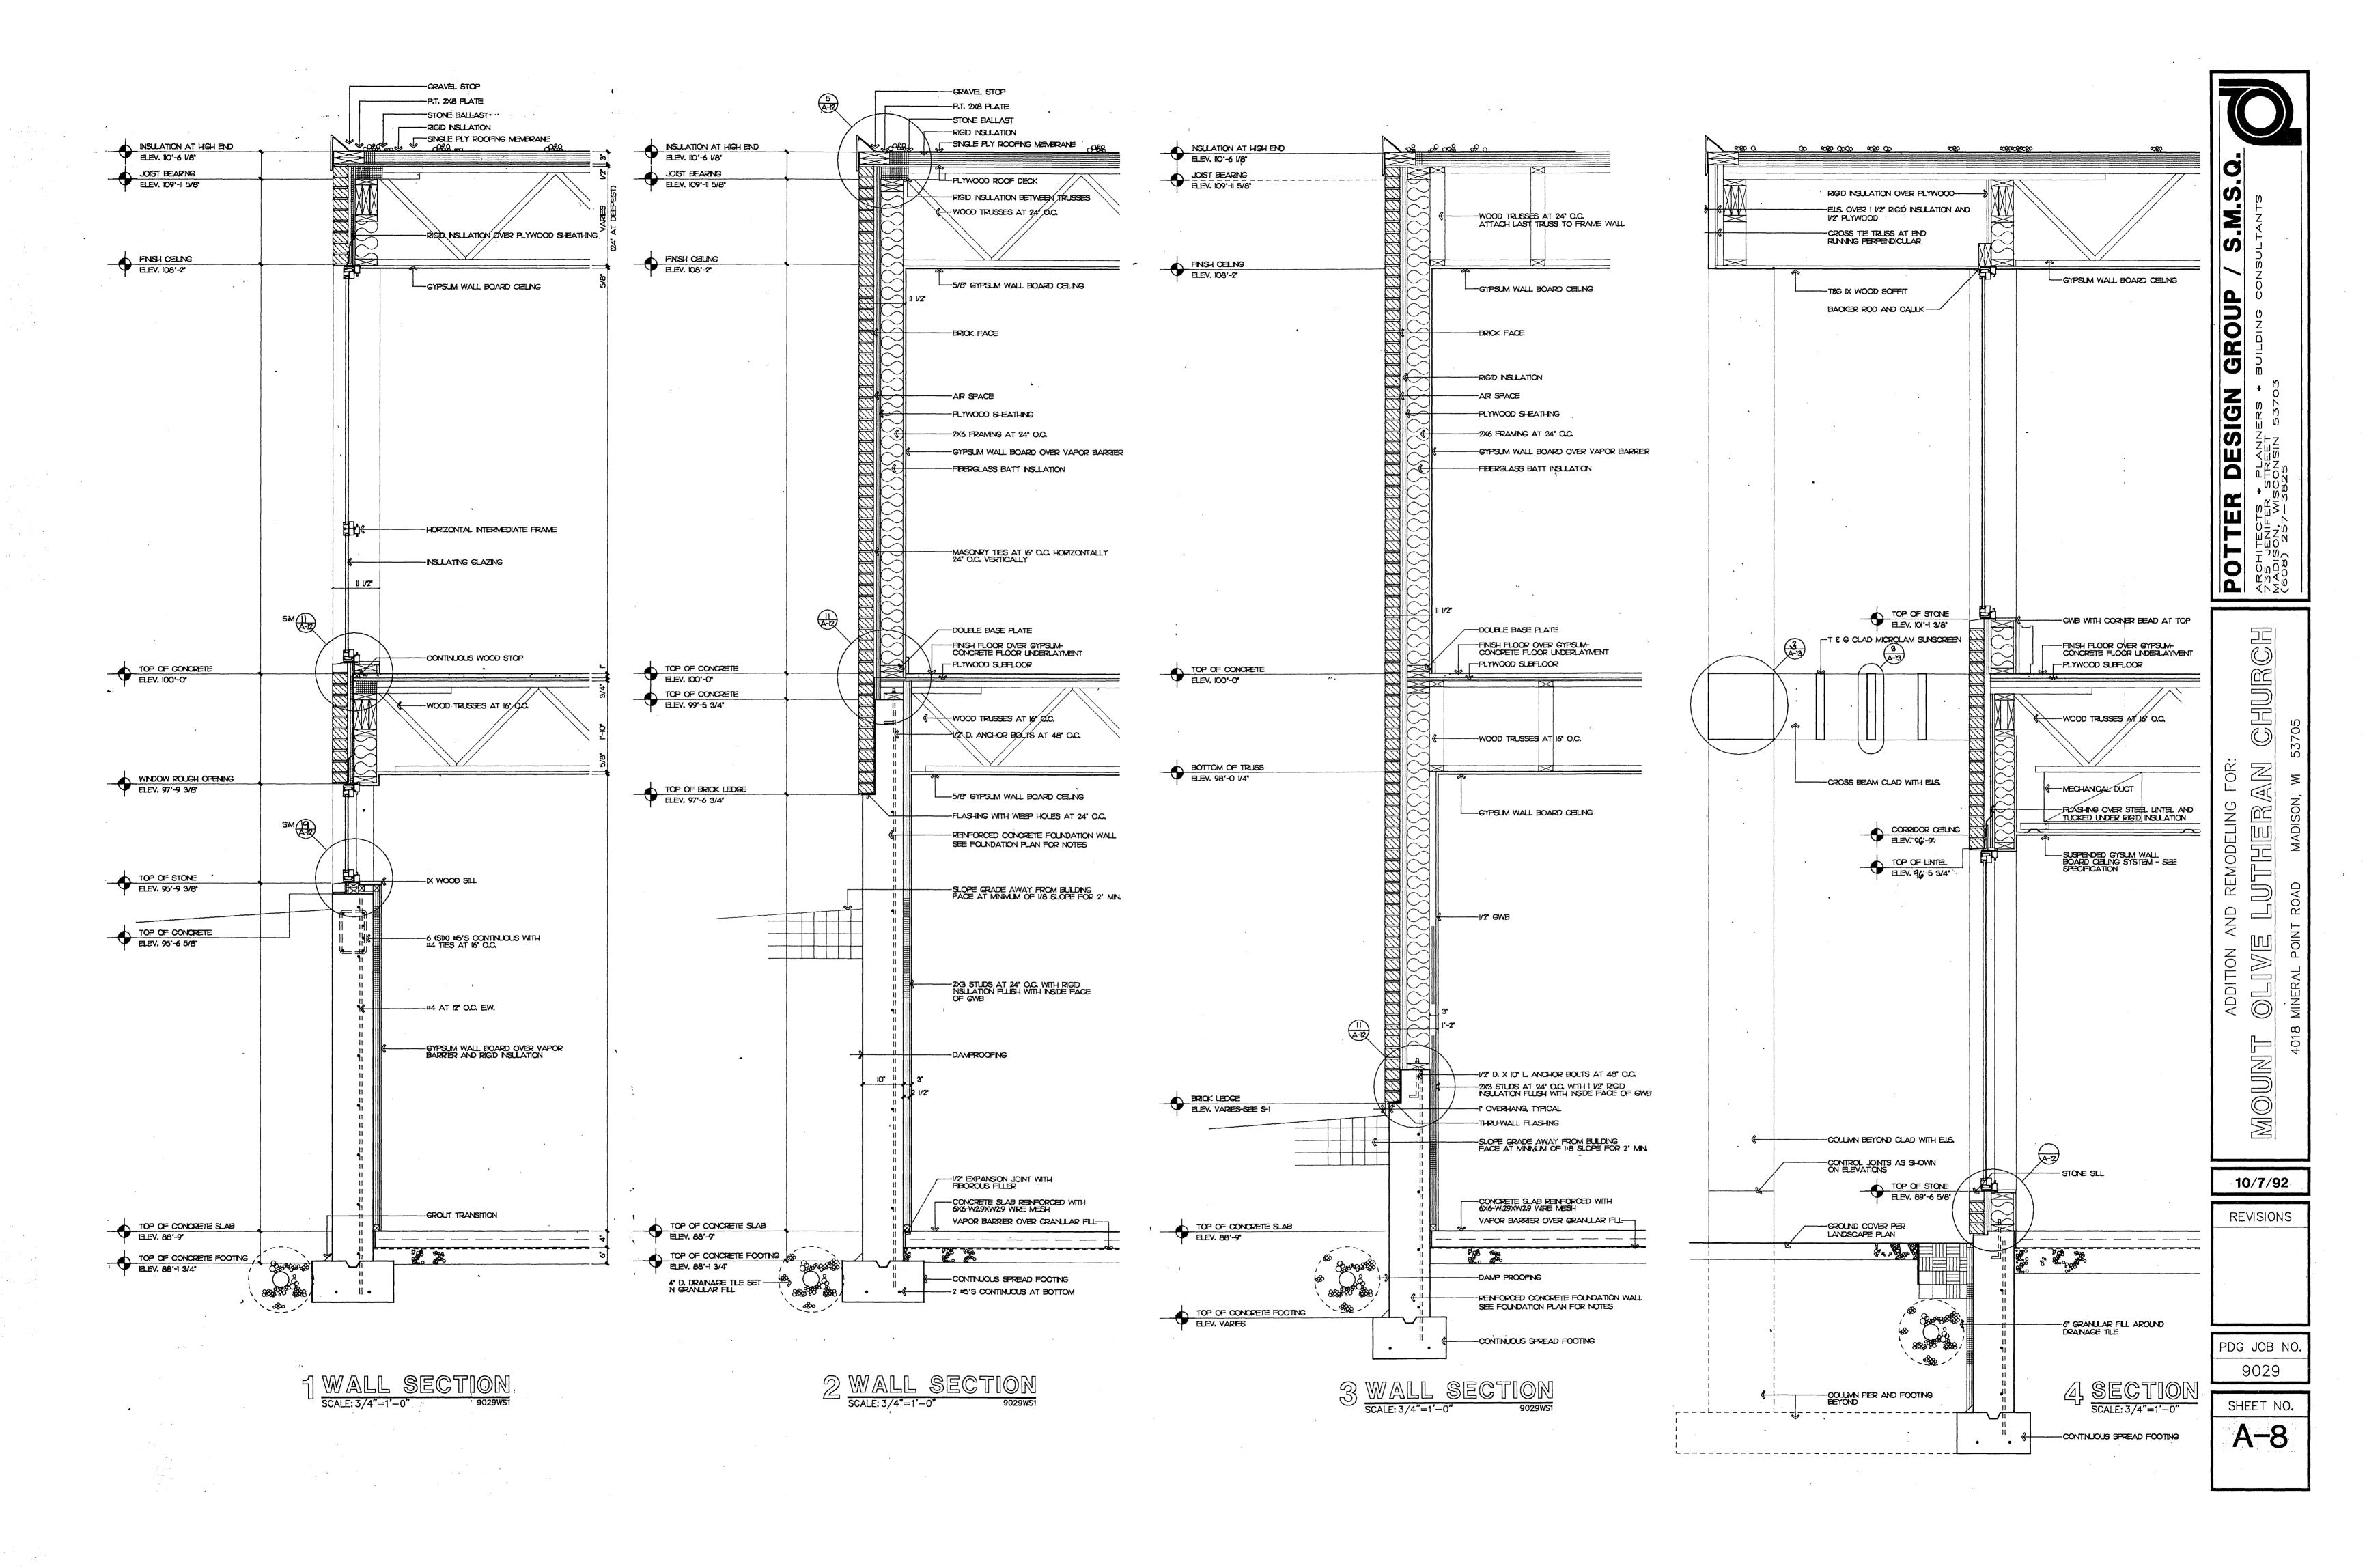

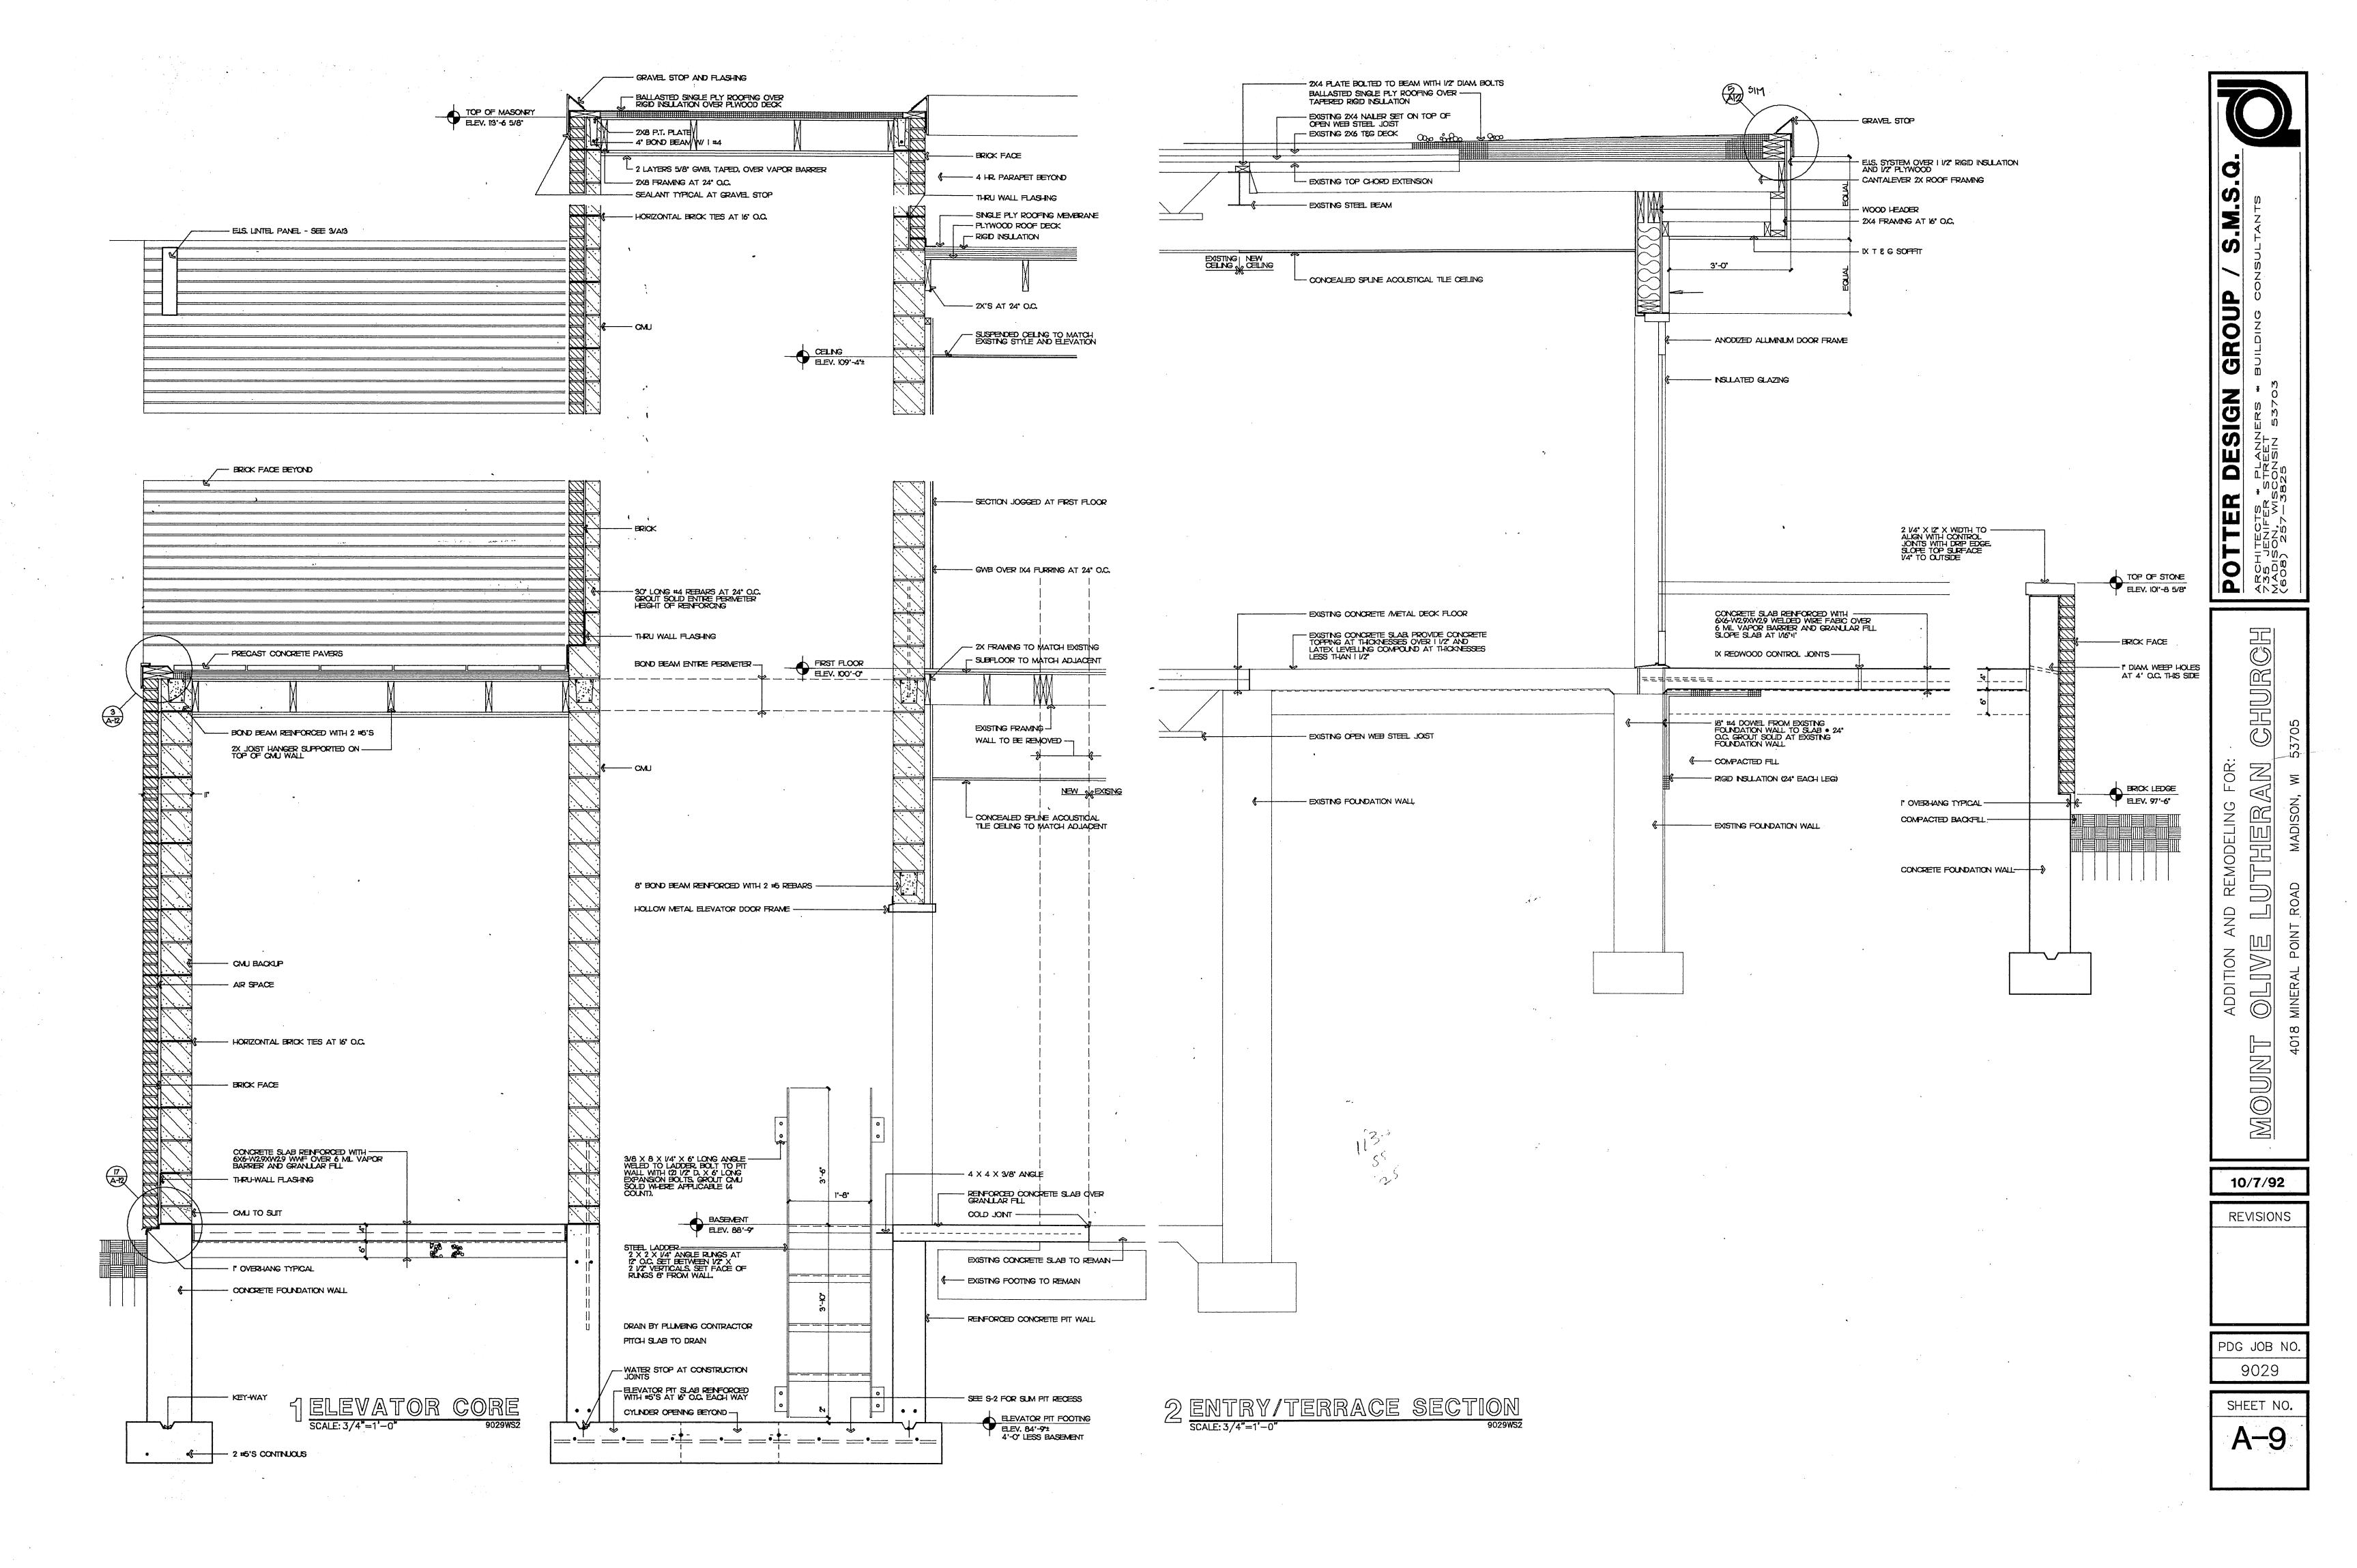

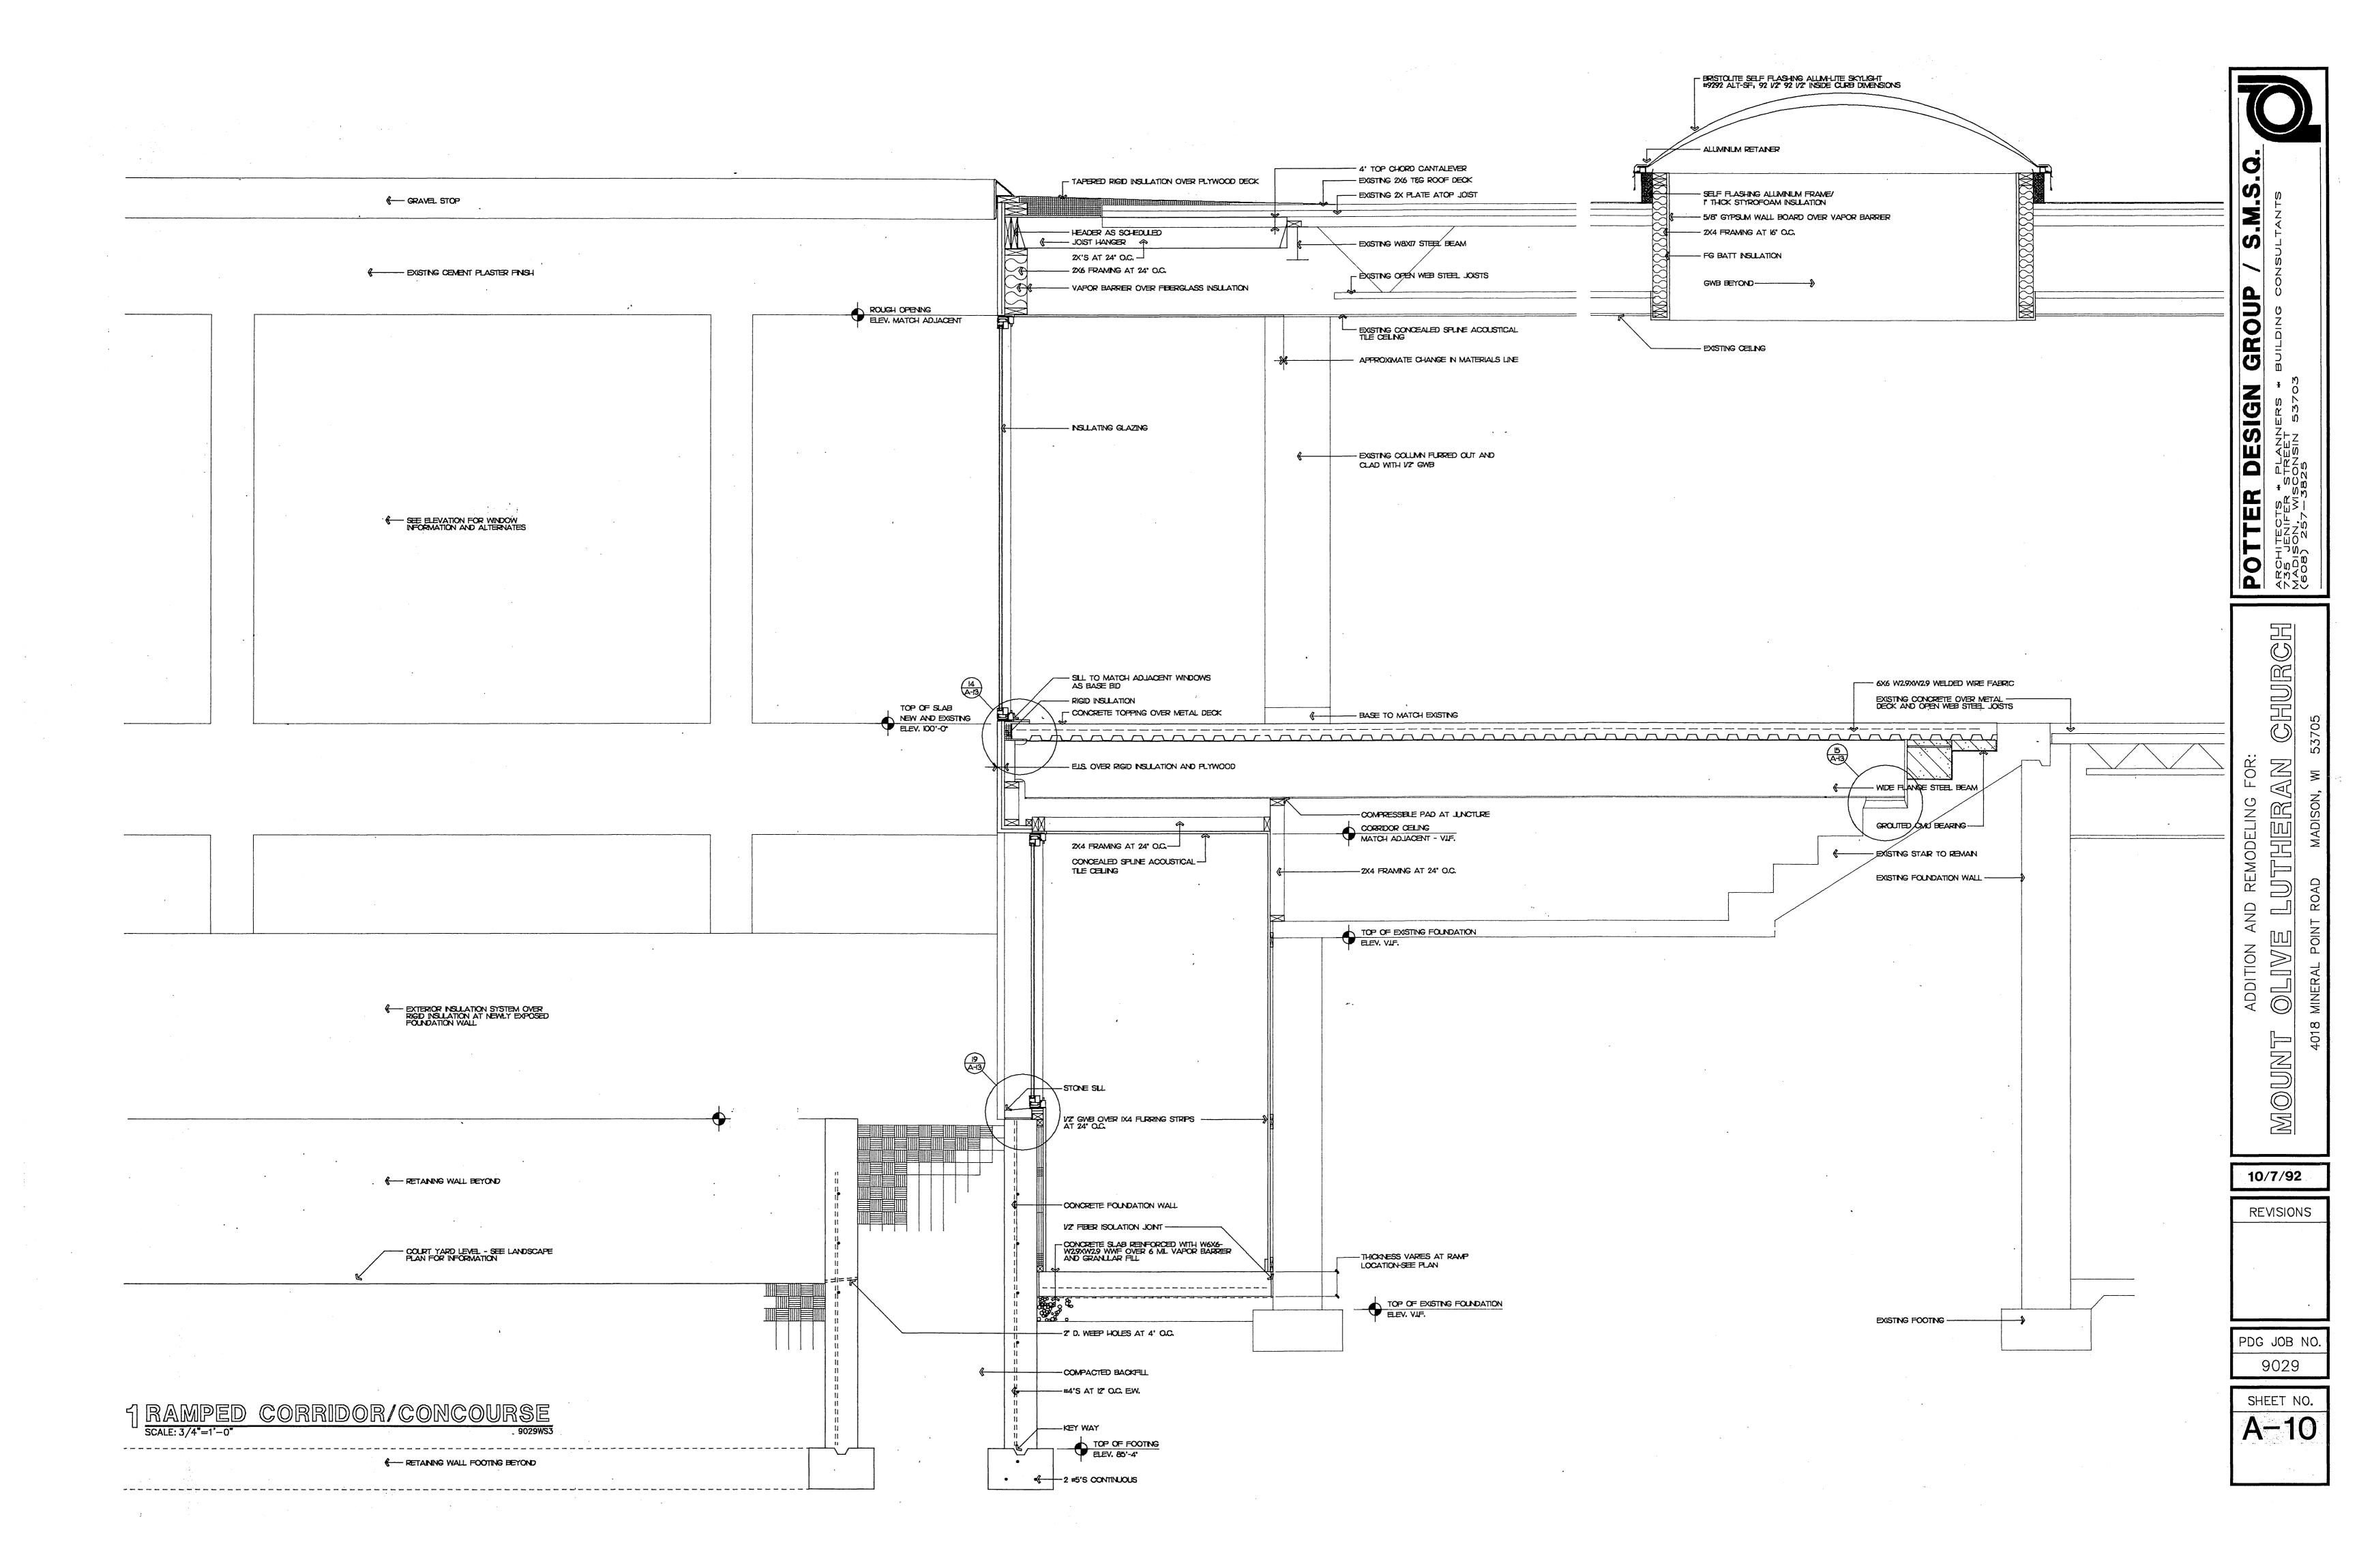

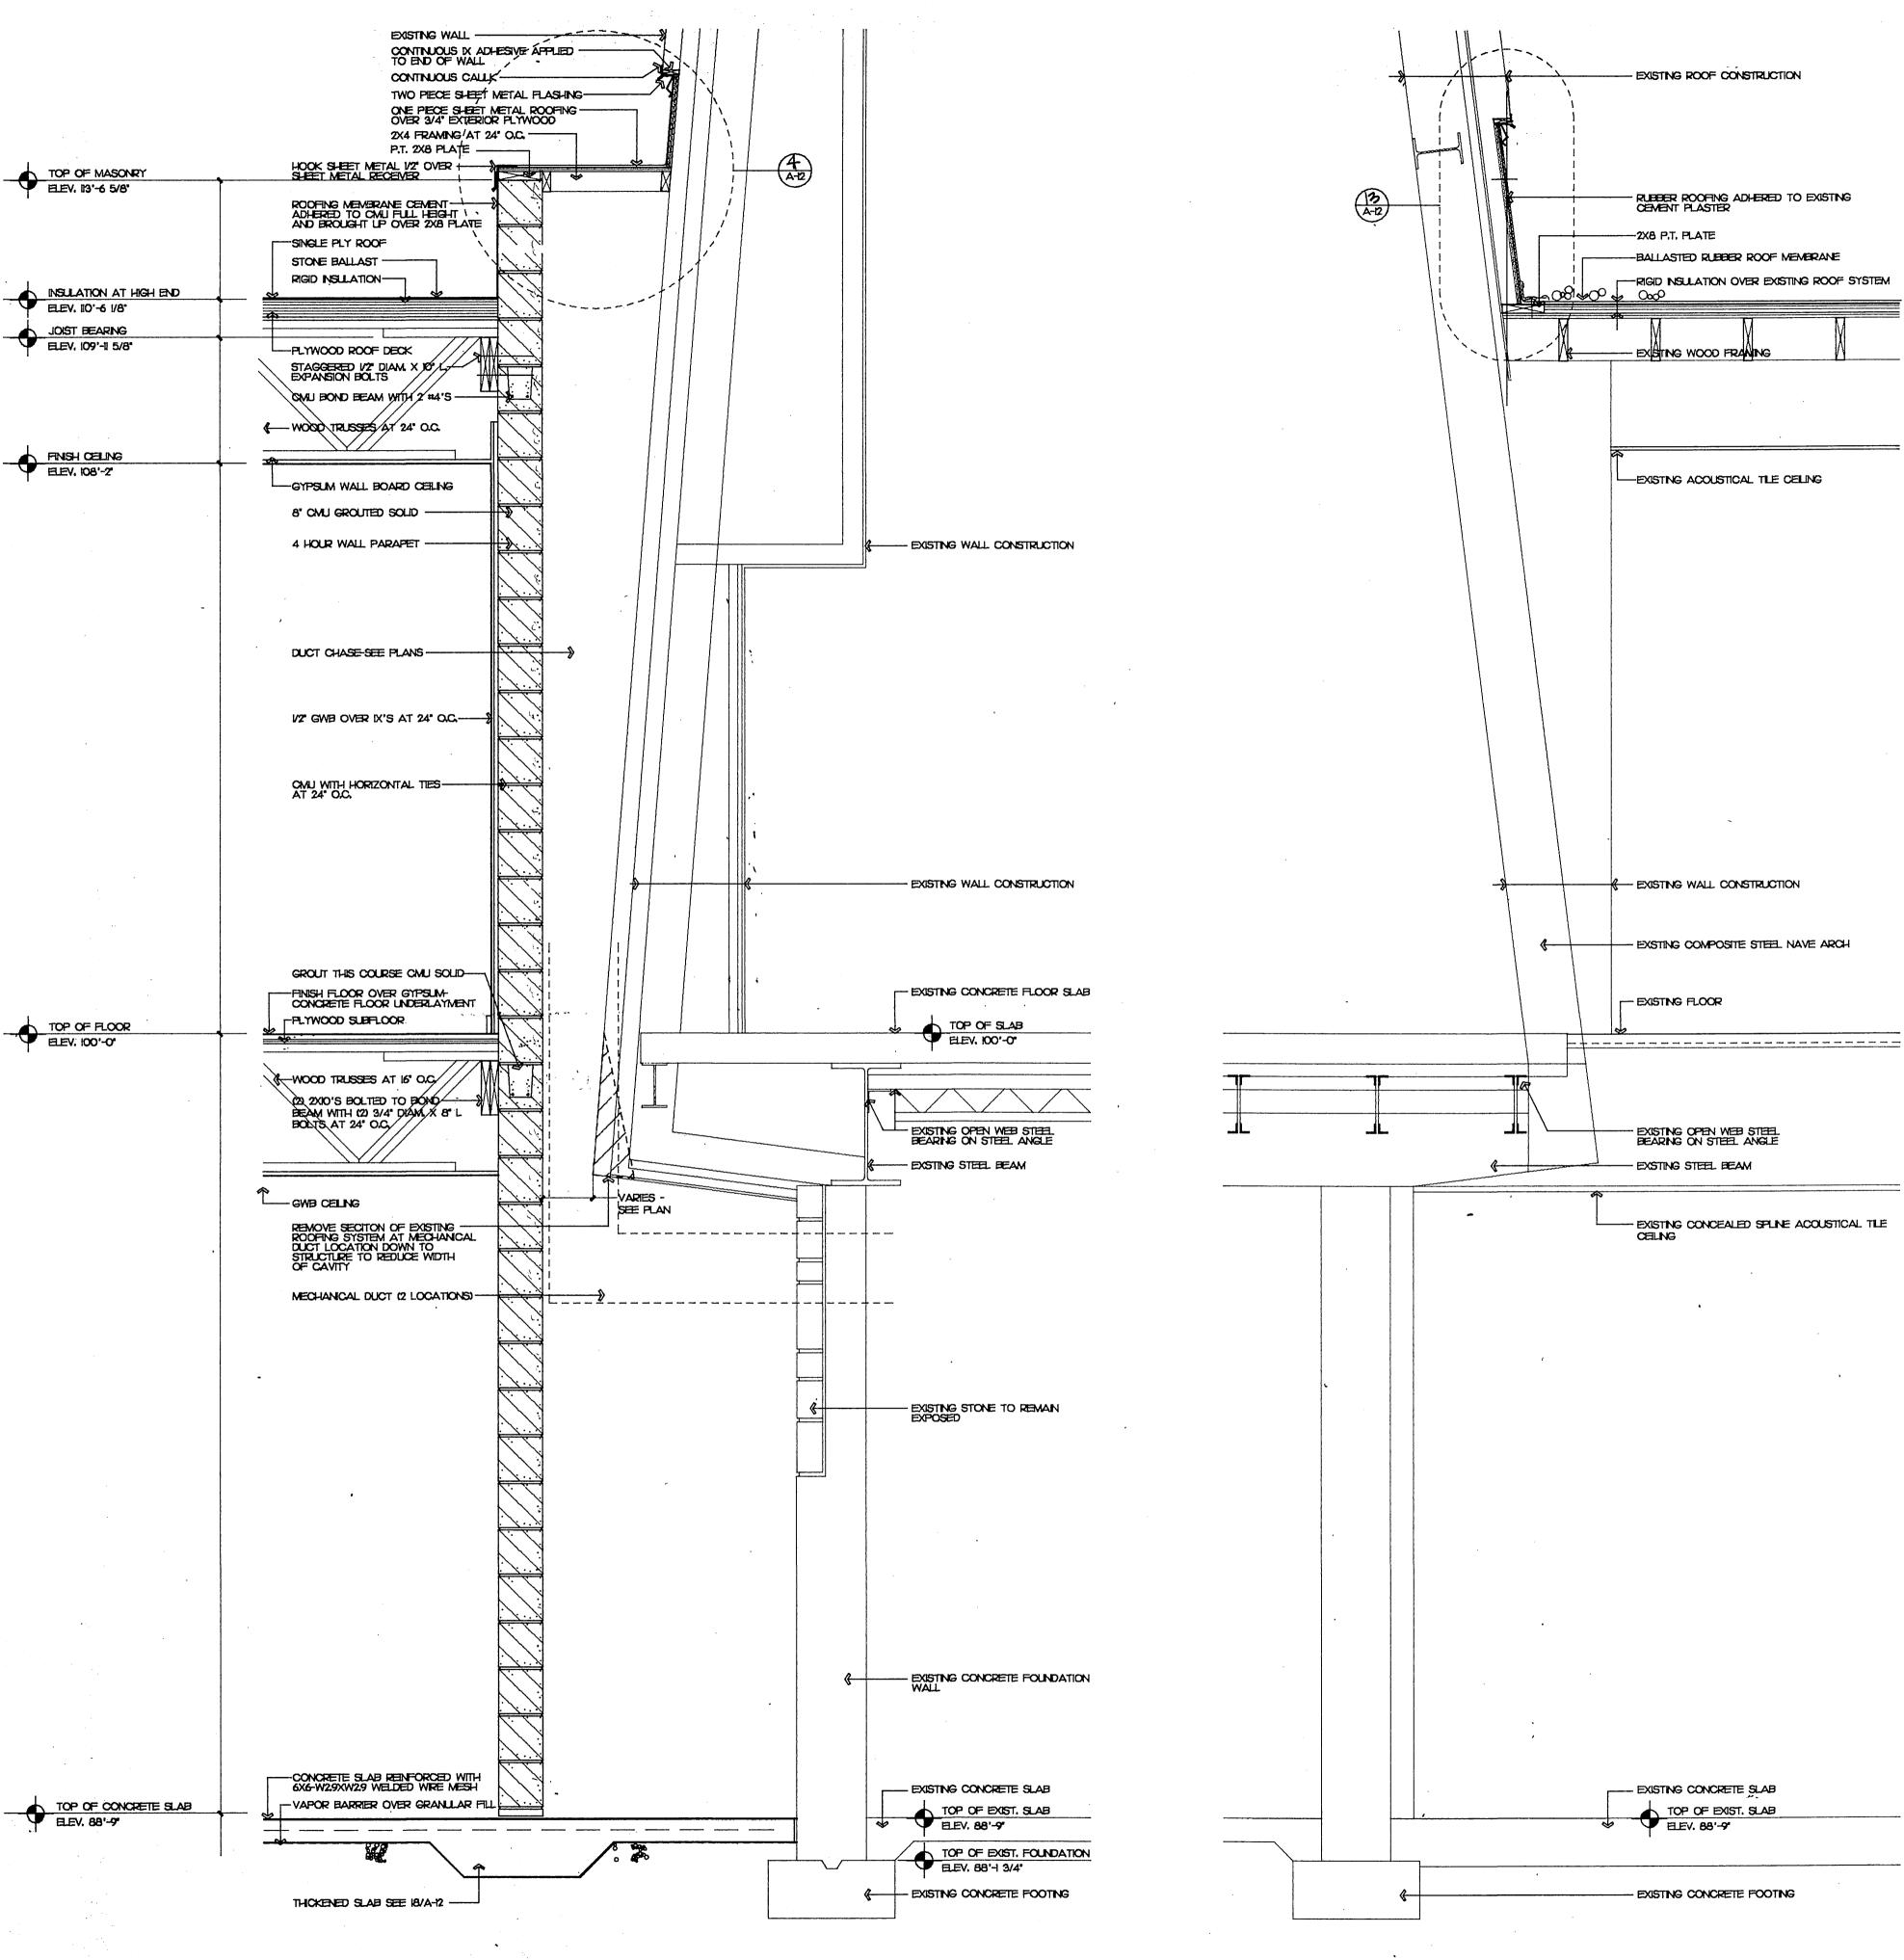

SCALE: 3/4"=1'-0"

ARCHITECTS \* PLANNERS \* BUILDING CONSULTANTS
735 JENIFER STREET
MADISON, WISCONSIN 53703
(608) 257-3825

ADDITION AND REMODELING FOR:
MOUNT OLIVE LUTHERAN CHURCH


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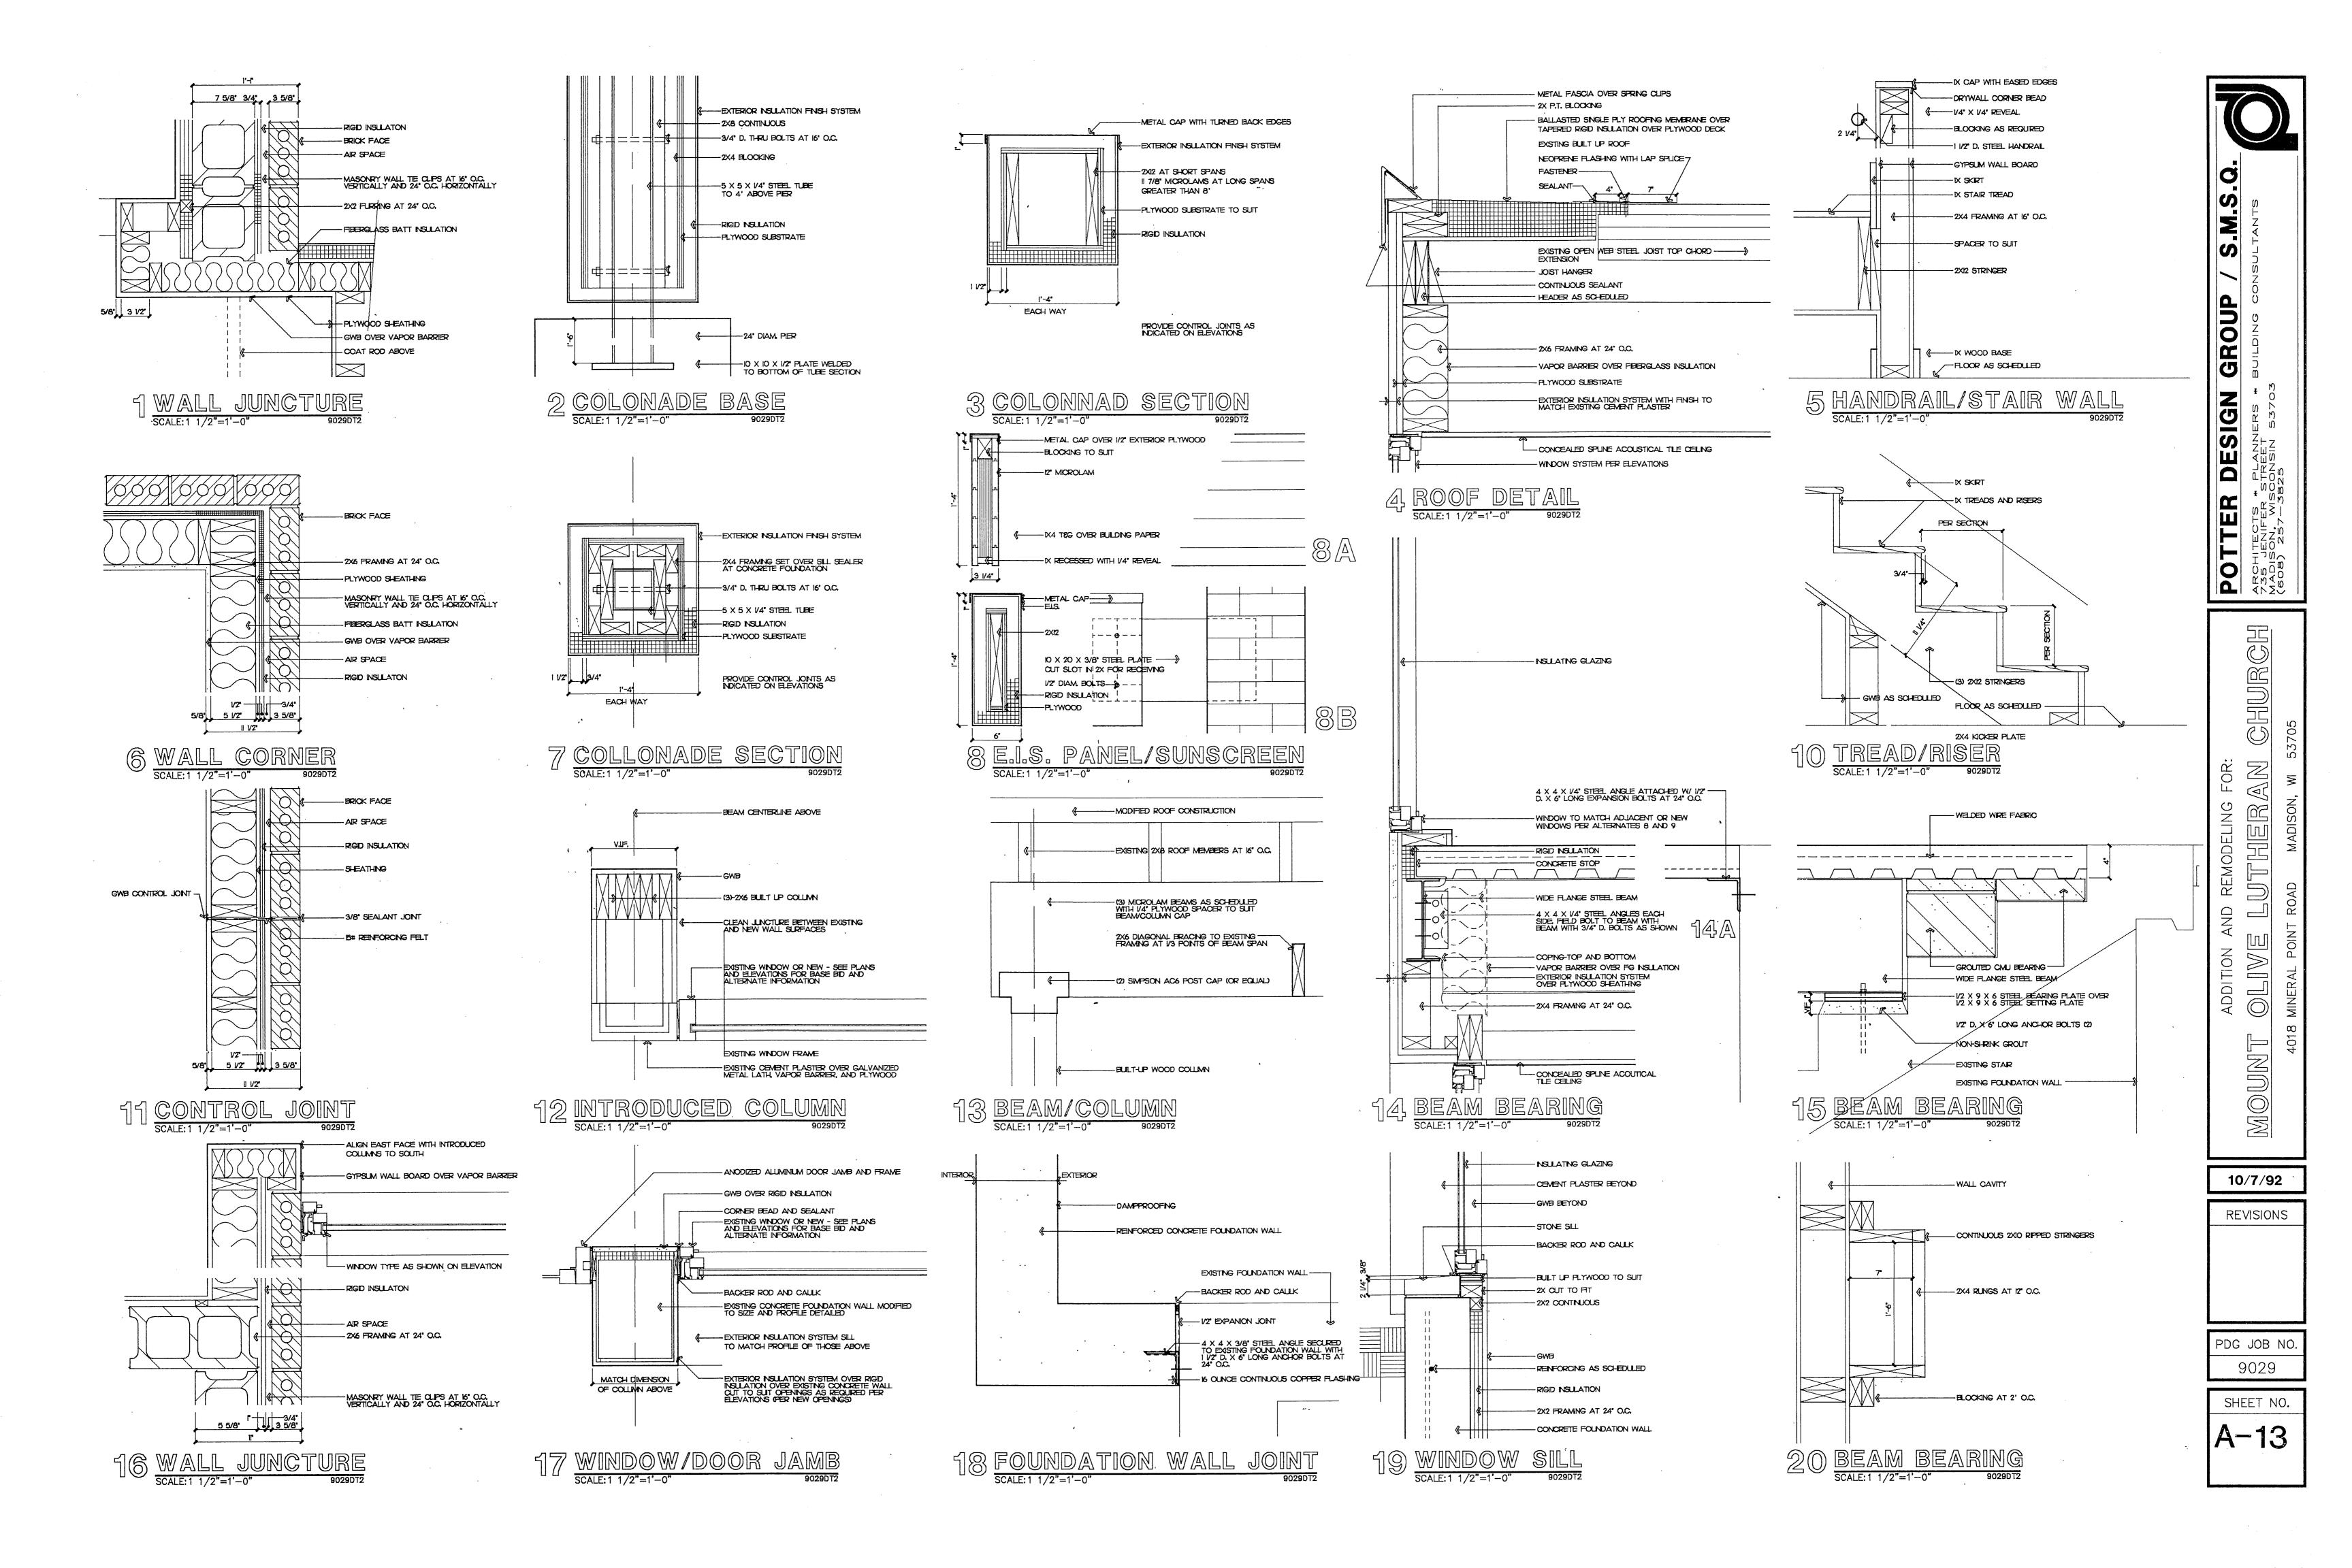
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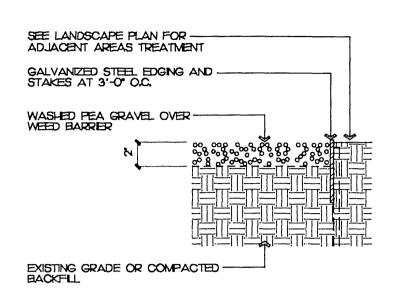
PDG JOB NO. 9029

SHEET NO.


SANCTUARY WALL SECTION
SCALE 3/4"=1'-0"







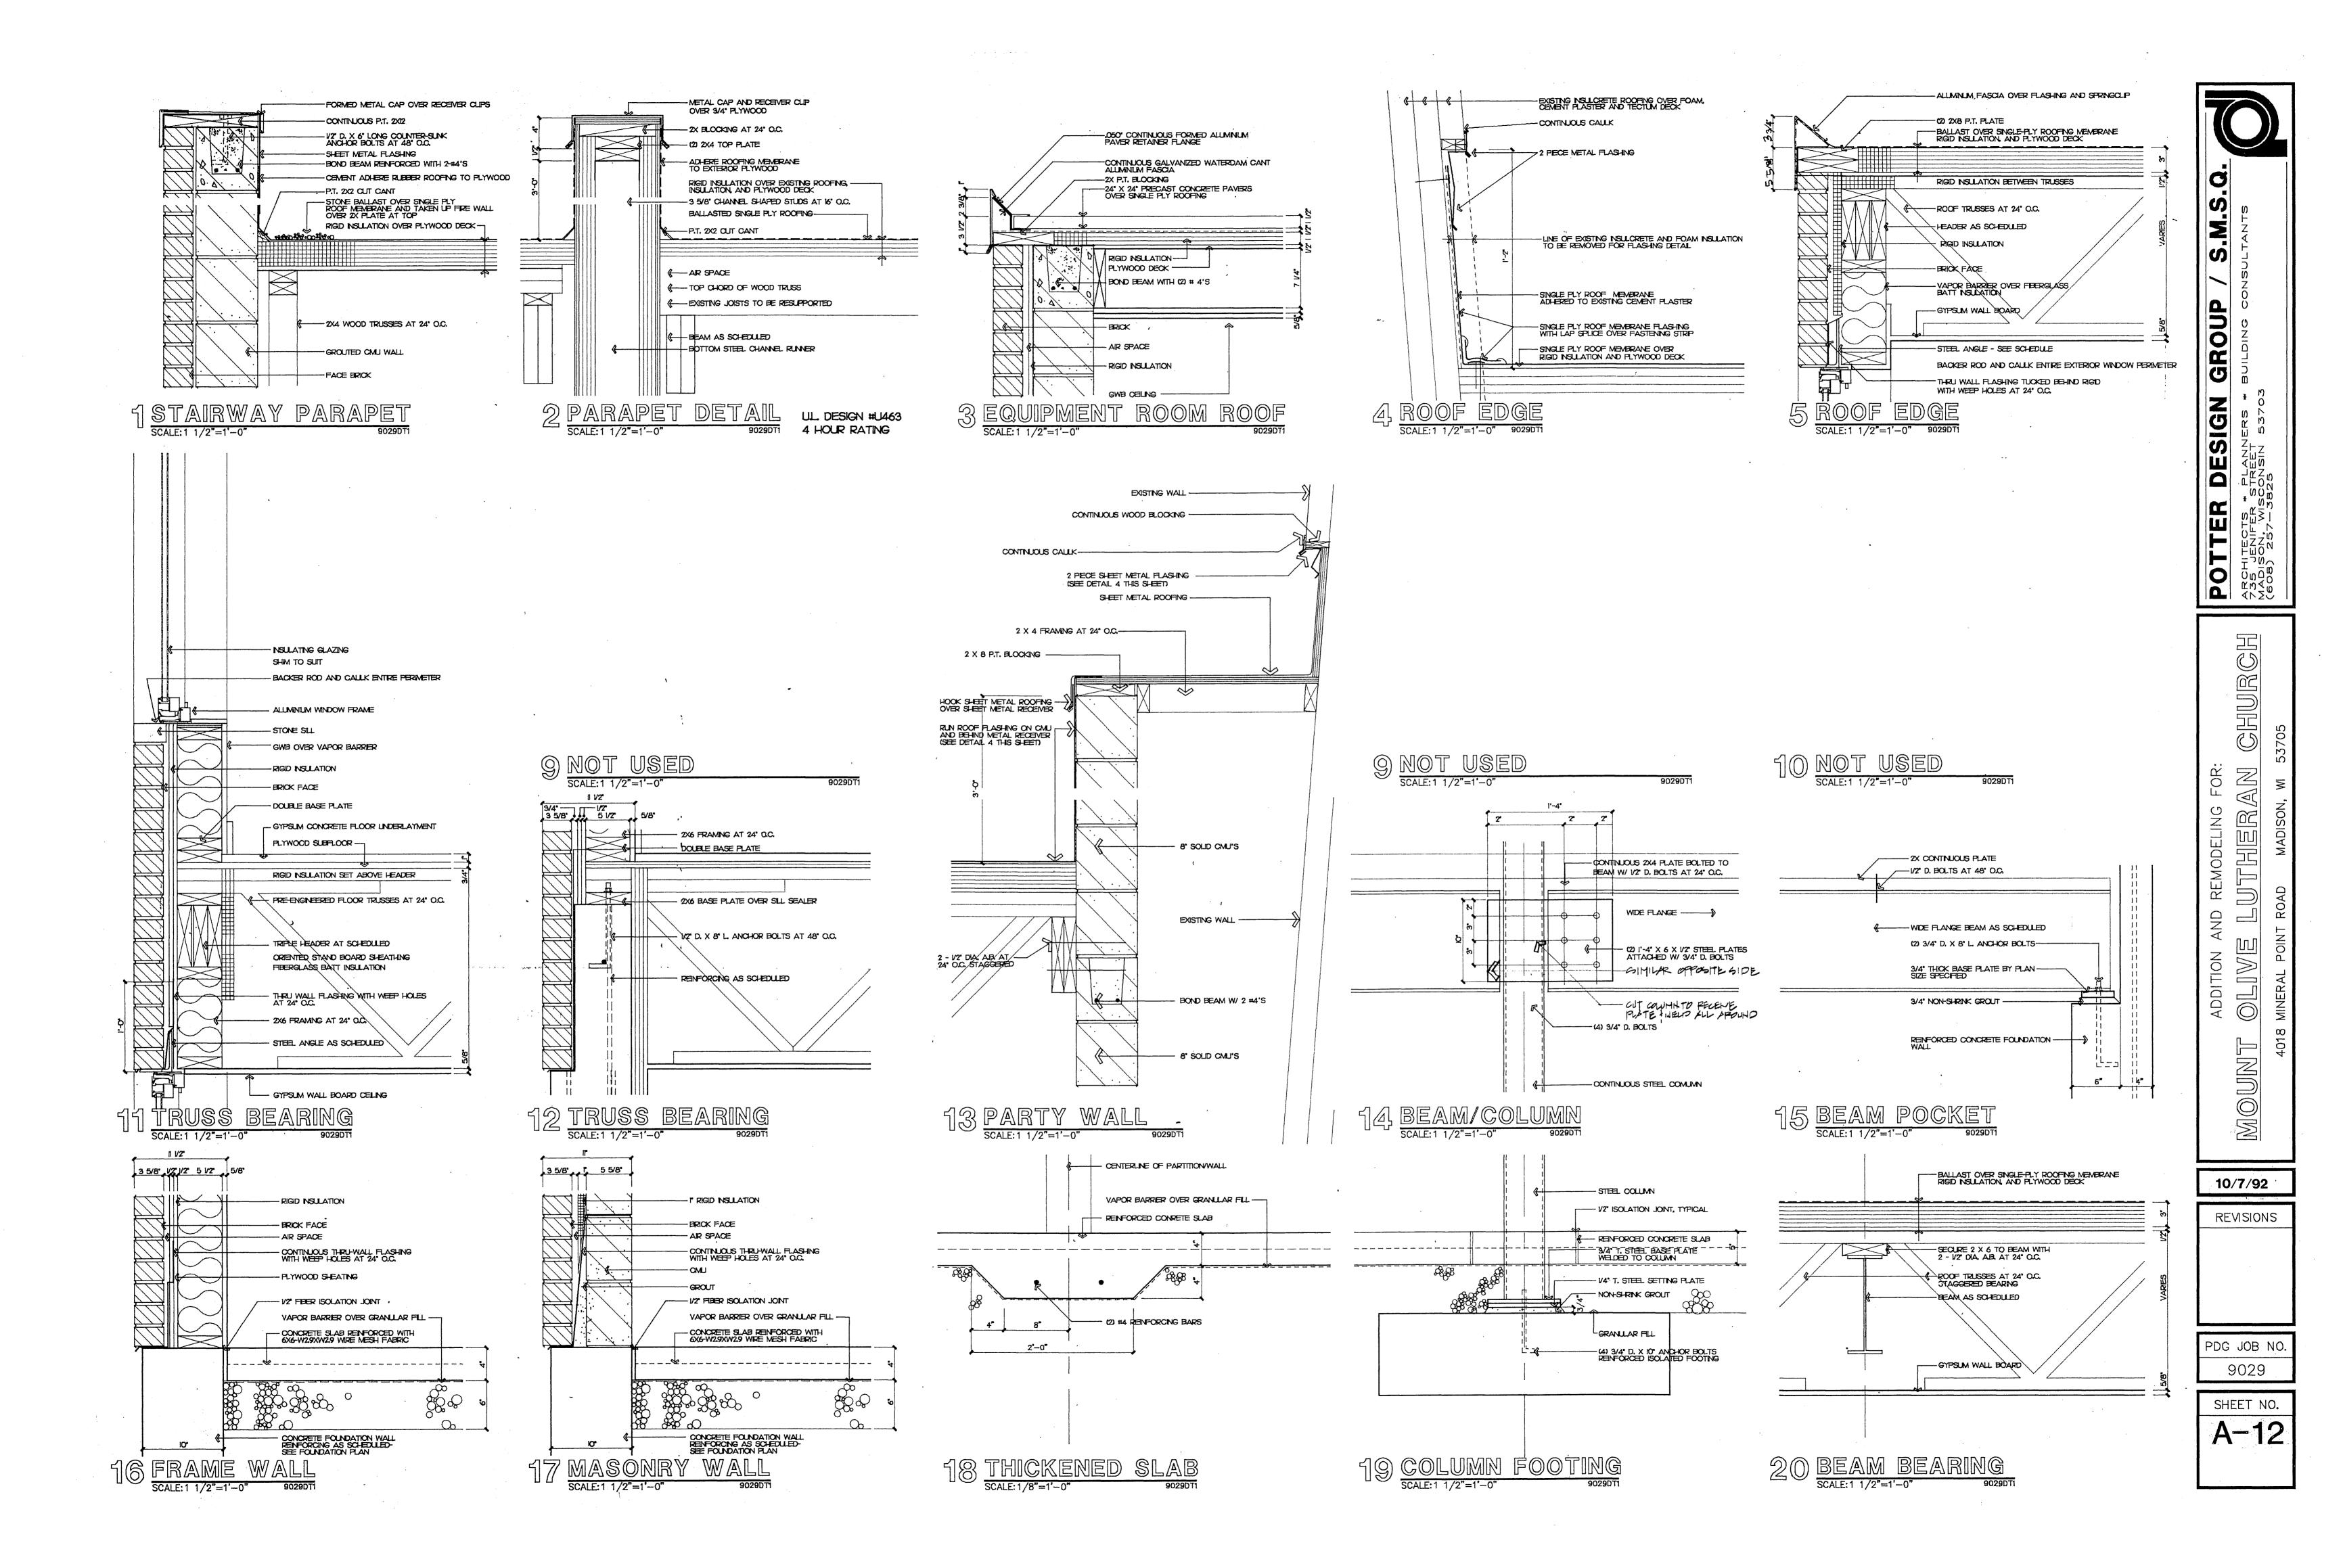



1 STEEL E

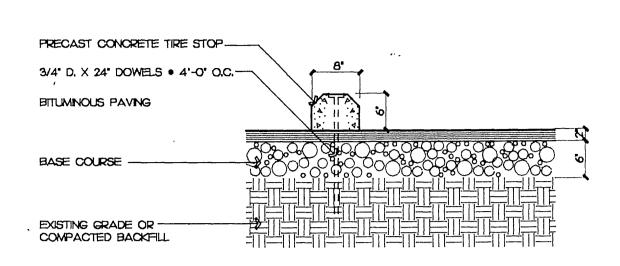

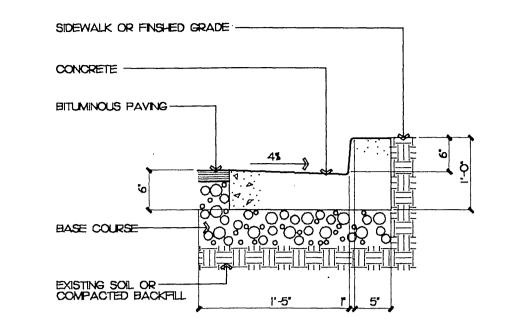

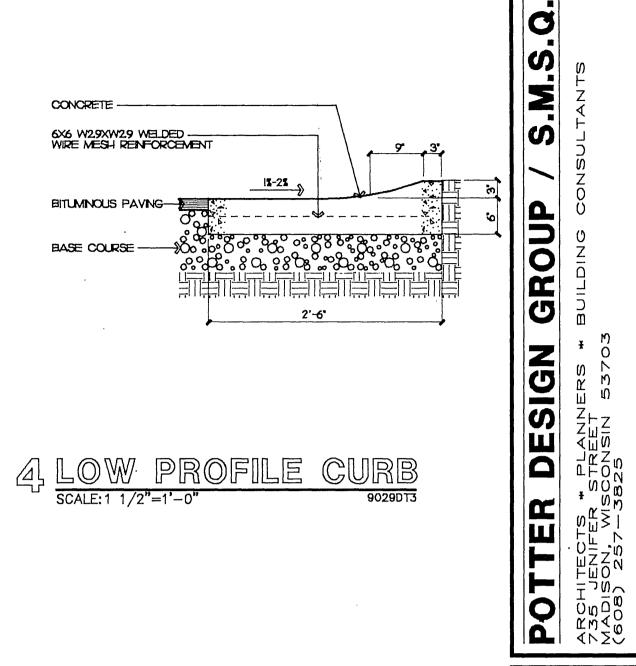

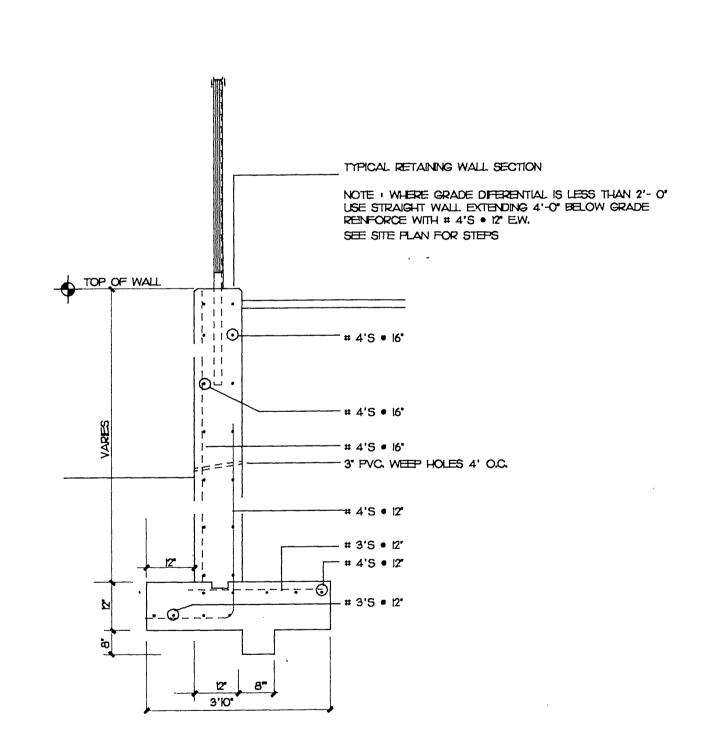

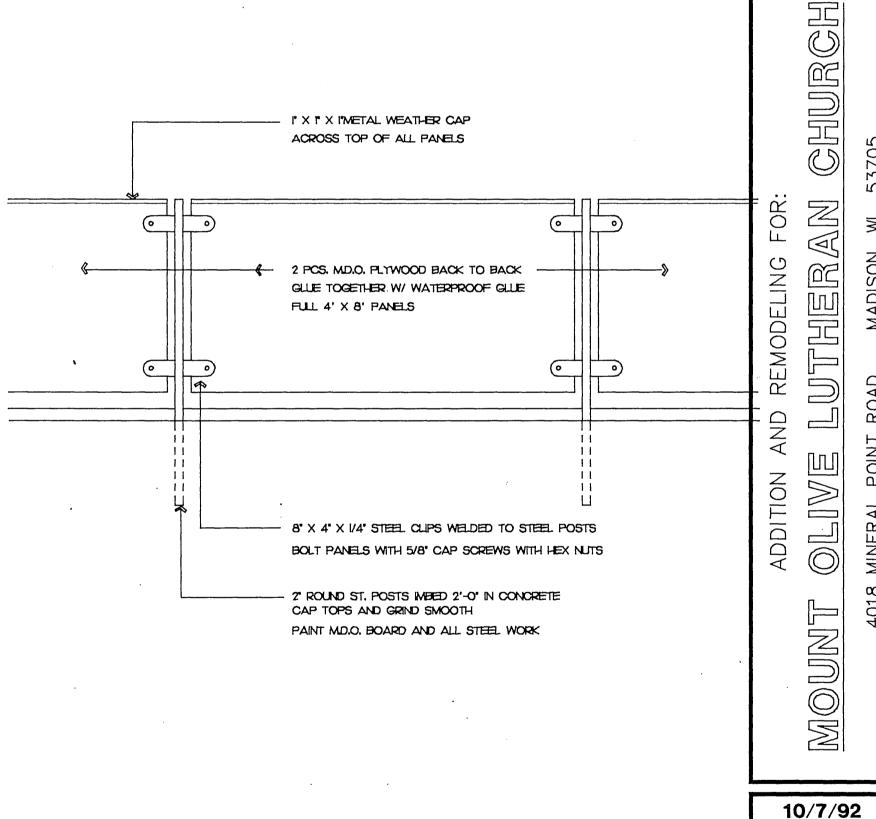

10/7/92

REVISIONS

PDG JOB NO. 9029

> SHEET NO. A-14

11 (						ツムに				FLOOR			U) G			DUL		<u> </u>	<u> </u>				<u>'J</u>		
ООМ О.	ROOM NAME	FLOOR	BASE	WALL I NORTH	WALL 2 EAST	WALL 3 SOUTH	WALL 4 WEST	CELING	CELING	NOTES	DOOR NO.	WIDTH	HEIGHT	THICK	TYPE	DOOR CONST.	GLASS	FRAME CONST.	HEAD DETAIL	JAMB DETAIL	SILL	LOUVER	u'aut	HRDWR.	NOTES
i	SANCTUARY									EXISTING	EIOIA														EXIST
2	STORAGE									EXIJTING	EIOIB														EXIST
3	STORAGE	<b></b>								EXISTING	EIOIC		ļ												EXIST
4	CONCOURSE	VARIES	WOOD	GWB/P	GWB/P .	-WB/P	GWB/P	VARIES	8'-2"	SEE PLANS	EIOD		ļ									ļ	<u> </u>		EXIST
5	VESTIBULE	CERAMIC	WOOD	GWB/P	GWB/P	GWB/P	GWB/P	VARIES	8'-2"	-	EIOIE .		ļ											ļ	EXIST
6	TWO YEAR OLD			ļ	<del> </del>	<del> </del>			<del> </del>	EXISTING	EOF							· · · · · · · · · · · · · · · · · · ·	<u> </u>						EXIST
7	ADULT/CHOIR CHOIR STORAGE			<del> </del>	<del> </del>		<del> </del>		<del> </del>	EXISTING EXISTING	E102 E103		<del> </del>				<del> , , ,</del>		<del> </del>	<del> </del>	<del> </del>		<del> </del>		EXIST
9	NURSERY			<del> </del>		<del></del>	ļ			EXISTING	104A	36	84	1 3/4	В	ALLIM	TEMP	ALUM		<u> </u>	-	-	-	4	-
	TOLET			-	<del> </del>		<del> </del>			EXISTING	104B	36	84	1 3/4	В	ALLIM	TEMP	A:UM	-	_	-	-	-	4	-
	SACRISTY			<del> </del>	1					EXISTING	104C	36	84	1 3/4	B	ALLIM	TEMP	ALUM	-	-	†-	_	-	4	_
	TERRACE	SEE PLAN	S AND ELL	EVATIONS		1					.104D	36	84	1 3/4	В	MLTA	TEMP	ALLIM	-	-	-		1-	4	-
	STAR D			1						EXISTING	104E	36	84	13/4	₿	ALLIM	TEMP	ALUM	-	-	-	-	-	4	-
	BONNE	CARPET	WOOD	GWB/P	GWB/P	GWB/P	GWB/P	GWB/P	8'-2"	-	·105A	36	84	1 3/4	В	ALLIM	TEMP	ALUM	-	-	-	-	Ī-	ī	-
	LARRY	CARPET	WOOD	GWB/P	GWB/P	GWB/P	GWB/P	ĠWB/P	8'-2"	_	105B	36	84	1 3/4	B	ALLM	TEMP	ALUM	-	-	-	-	-	2	
	BOB	CARPET	WOOD	GWB/P	GWB/P	GWB/P	GWB/P	GWB/P	8'-2"	-	105C	36	84	1 3/4	В	ALLIM	TEMP	ALLIM	-	-	-	-	<u> </u> -	5	-
	LNDA	CARPET	WOOD	GWB/P	GWB/P	GWB/P	GWB/P	GWB/P	8'-2"	-	1050	36	84	13/4	B	ALLIM	TEMP	ALUM	-		-	ļ- <u>·</u>	<u> </u>	5	-
	CONF/CLASS	CARPET	WOOD	GWB/P	GWB/P	GWB/P	GWB/P	GWB/P	8'-2"	-	106							<u> </u>			ļ	ļ	<del> </del>		EXIST
	ACT/COMPUTER	CARPET	WOOD	GWB/P	GWB/P	GWB/P	GWB/P	GWB/P	8'-2"	-	107A	36	<del> </del>			STING TO E		<del> </del>		ļ	<del> </del>			6	NEW
)	LOUNGE	CARPET	MOOD	GWB/P	GWB/P	GWB/P	GWB/P	GWB/P	8'-2"	-	107B	36	<del> </del>			STING TO E				ļ			<del> </del>	6	NEW
	OFFICE	CARPET	WOOD	GWB/P	GWB/P	GWB/P	GWB/P	GWB/P	8'-2"	ļ	109	36	KEUSE	UR MA	CH EXI	STING TO E	E REMOVE	D HM		ļ			-	6	NEW
	KAY	CARPET	WOOD	GWB/P	-	GWB/P	GWB/P	GWB/P	8'-2"	-	EIIO	ļ	<del> </del>					ļ			<del> </del>		<del> </del>	<del> </del>	EXIST
3	WAITING	CARPET	WOOD	GWB/P	<del> </del>		GWB/P	GWB/P	8'-2"	-	<u> </u>	24	DA.	1 3/4		SCW		HM	<del> </del>	<u> </u>		-	<del> </del>		EXIST
4	CORRIDOR	CARPET	WOOD	GWB/P		GWB/P	<del></del>	GWB/P	8'-2"	-		36	84	1 3/4	A D	SCW -	-	HM		<del>  -</del>	10/10	-	<del>-</del>	6	ļ <u>.</u>
5	ENTRY LE	CARPET	WOOD	GWB/P	SEE ELEV		SEE ELEV	GWB/P	8'-2"		115	36	84	1 3/4	ר	5CW -		LIM	1	<u> </u>	12X12 12X12	<u> </u>	+	6	<del> </del>
	VESTIBULE WOMEN'S	CERAMIC		· · · · · · · · · · · · · · · · · · ·	GWB/P	GWB/P	GWB/P	GWB/P	8'-2"		117	36	84	1 3/4	D	SCW		HM	_	-	12X12	-	+	6	+
3	JANITOR	VINYL	VINYL	GWB/P	GWB/P	GWB/P	GWB/P	GWB/P	8;-2*	_	118	36	84	1 3/4	D	SCW	_	HM	-	-	12X12		-	6	1_
	MEN'S	CERAMIC	CERAMIC	GWB/P	GWB/P	GWB/P	GWB/P	GWB/P	8 -2"	±	119	36	84	1 3/4	D	SCW	-	НМ	<del>  -</del>	-	12>32	-	†	6	1_
	FIVE YEAR OLD	VINYL	WOOD	GWB/P	GWB/P	GWB/P	GWB/P.	GWB/P	8'-2"	-	120	36	84	1 3/4	A	SCW	-	НМ	-	-	-	-	_	7	1_
	FOUR YEAR OLD	CARPET	WOOD	GWB/P	GWB/P	GWB/P	GWB/P	GWB/P	8'-2"	-	121	36	84	1 3/4	Α	SCW	-	НМ	-	-	-	-	-	7	-
2	FIRST GRADE	CARPET	WOOD	GWB/P	GWB/P	GWB/P	GWB/P	GWB/P	8'-2"	-	·126A	36	84	1 3/4	B	ALLIM	TEMP	ALUM	-	-	-	-	-	2	-
3	THREE YEAR OLD	CARPET	WOOD	GWB/P	GWB/P	GWB/P	GWB/P	GWB/P	8'-2"	-	12613	36	84	1 3/4	В	ALLM .	TEMP	ALUM	-	-	-	-	-	2	-
4	CORRIDOR	CARPET	WOOD	GWB/P	GWB/P	GWB/P	GWB/P	GWB/P	8'-2"	-	126C	36	84	1 3/4	B	ALLIM	TEMP	ALLIM	-	-	-	-	-	ı	-
5	STAIR A	CARPET	WOOD	GWB/P	GWB/P	GWB/P	GWB/P	GWB/P	VARIES	-	126D	36	84	1 3/4	В	ALUM	TEMP	ALUM	-	_		-	-	2	_
5	STAIR B	CARPET	WOOD	GWB/P	GWB/P	GWB/P	GWB/P	GWB/P	VARES		126E	36	84	1 3/4	B	ALUM	TEMP	ALUM	-		-	-	<u>  -                                   </u>	5	-
7	STAIR C	CARPET	WOOD	GWB/P	GWB/P	GWB/P	GWB/P	GWB/P	VARES		126=	36	84	13/4	B	ALUM	TEMP	ALUM	ļ -	<u> </u>	-	-	ļ	5	-
								ļ			126G	36	84	1 3/4	В	ALLIM	TEMP	ALUM	-	-	-	-	<u> </u>	5	-
							-				1261-1	36	84	1 3/4	B	ALLIM	TEMP	ALUM		ļ	-	-	-	5	ļ
											127	36	84	1 3/4	D	SCW ·	-	HM	-	-	12X12	-		9	-
				ļ	<del> </del>	-			<del></del>		128	36	84	1 3/4	D	SCW	-	HM	-	-	12X12	-	-	10	<del> -</del>
		<b> </b>		-					-	<del> </del>	129	36	84	1 3/4	D	SCW -	-	HM	-	-	12XI2	ļ	-	9	ļ
	<u></u>	<u></u>	<u> </u>	1	1		<u> </u>	<u> </u>	1		130	36	84	1 3/4	D	SCW		HM	-	<del>-</del>	12.112	<del> </del>	<del> </del>	6	-
											131	36 36	84	1 3/4	D	SCW -		HM	-	<u> </u>	12%2	<u> </u>	+	6	+
											133	36	84	1 3/4	ם	SCW -		HM HM	<del> </del>	<del>-</del>	12X12 12X12	<u>  -                                   </u>	+	6	<del> </del>
											135A	35	84	1 3/4	В	ALLIM	TEMP	ALUM	-	-	-	<del> -</del>	+	3	+-
											1358	35	84	1 3/4	В	ALLIM	TEMP	ALUM	-	-	_	<del> </del>	<del>  -</del>	4	
											137A	38	84	1 3/4	В	ALUM	TEMP	ALLIM	-	-		-	-	3	<del> </del>
											1378	38	84	13/4	B	ALUM	TEMP	ALUM	-	-	-		-	4	<b> </b>
																			<del></del>		<u> </u>				
T JN: NST	CONSTRUCT:ON  ELEVATION  EXPOSED  FRAME  GYPSUM WALL BO		HR HRDMI NO P SCW TEMP U'CUT	PAINT SOLID TEMPE	R CORE WOO RED	DD	1	3			DOO	₹ TYF	ES	· July van Se value						e meetitem va		[		L DIMEI 'SK HEDULE'S /	
<u> </u>	HOLLOW METAL		1											_	<b>、</b> . L	,	_	L		_	Ļl				
				·							A			E	3	:	C			D					

ROOM NO.	ROOM NAME	FLOOR	BASE	WALL I NORTH	WALL 2 EAST	WALL 3 SOUTH	WALL 4 WEST	CEILING	CELLING HEIGHT	NOTES
001	FELLOWSHIP	1 LOOK	DAOL	110/01/11	2,70					EXISTING
002A	8TH GRADE						GWB/P			EXISTING
002B	CART STORAGE			· · ·	GWB/P		<u> </u>	····		EXISTING
003	MEN'S									EXISTING
004	WOMEN'S									EXISTING
005	CORRIDOR									EXISTING
006	CORRIDOR	CARPET	WOOD					ACT	9'-24	-
007	CLASSROOM			<del>                                     </del>						EXISTING
008	CLASSROOM									EY TING
009	BOILER ROOM									EXISTING
010	MAINTENANCE	E	E	E	GWB/P	GWB/P	E	E	9'-2"	-
Oll	RAMP	CARPET	WOOD	GWB/P	E	GWB/P	٤	ACT	9'-2'±	-
Ol2	CAVITY									
Ol3	CONCOURSE	CARPET	WOOD		E/P	E/P	E/P	E	9'-2 <b>"</b> ±	-
014	MECHANICAL						·			EXISTING
015	ANTEROOM									EXISTING
016.	STORAGE									EXISTING
017	TOILET ROOM									EXISTING
OIB	CORRIDOR	CARPET	WOOD	GWB/P	GWB/P	GWB/P	GWB/P "	GWB/P	9'-2"±	
019A	FUTURE	CARPET	WOOD	GWB/P	GWB/P	GWB/P	GWB/P	GWB/P	9'-2 <b>"</b> ±	<u> </u>
01993	TOILET	CARPET	WOOD	GWB/P	GWB/P	GWB/P	GWB/P	GWB/P	9'-2"±	
020	STORAGE	VINYL		GWB/P	GWB/P	GWB/P	GWB/P	GWB/P	9'-2 <u>"±</u>	-
021	MECHANICAL	EXP	-	EXP	GWB/P	GWB/P	GWB/P	GWB/P	9'-2"±	<u>-</u>
022	2ND GRADE	CARPET	WOOD	GWB/P	GWB/P	GWB/P	GWB/P	GWB/P	9'-2"±	! -
023	3RD GRADE	CARPET	MOOD	GWB/P	GWB/P	GWB/P	GWB/P	GWB/P	9'-2*±	
024	4TH GRADE	CARPET	MÕÕD	GWB/P	GWB/P	GWB/P	GWB/P	GWB/P	9'-2"±	1_
025	5TH GRADE	CARPET	GOOM	GWB/P	GWB/P	GWB/P	GWB/P	GWB/P	9'-2"±	-
026	6TH GRADE	CARPET	WOOD	GWB/P	GWB/P	GWB/P	GWB/P	GWB/P	9'-2"±	-
027	CORRIDOR	CARPET	WOOD	GWB/P	GWB/P	GWB/P	GWB/P	GWB/P		! -
028	EQUIPMENT	EXP	-	CMU/EXP	CMU/EXP	CMU/EXP	CMU/EXP	GWB/P	9'-2"±	-
,										i :
1										
			-							•
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			1						1	:

DOOR NO.	WIDTH	HEIGHT	TUICK	TYPE	DOOR CONST.	GLASS	FRAME CONST.	HEAD DETAIL	JAME DETAIL	SILL	LOUVER	u'cut	HRDWR.	
E00IA	THE	FILAOFIT	TENOIC	1116		OLAGO	00.00	DETAIL	DETAIL	- DETAIL	LOGVER	0 001	1101	1
EOOB							<del> </del>						<del> </del>	1
EOOIC							<del> </del>							-
EOOID								·					ļ	-
OOE	36	84	1 3/4	A	SCW	_	HM	_	-	_	-	_	<del>  -</del>	-
									-					-
E003														
E004														
E005A								-						_
E0058			•											
E006A														
0068	36	REUSE	OR MA	CH AD	JACENT EX	STING							-	
E007												:		
E008														_
E009													ļ	_
010	36	REUSE	OR MA	CH AD	JACENT EX	STING							10	_
OBA	36	84	1 3/4	В	ALLIM	TEMP	ALLIM	-	-	-	-	-	2	_
OBB	36	84	1 3/4	В	ALLIM	TEMP	ALLIM	-	-	-	-	-	1	
OBC	36	84	1 3/4	B	ALUM	TEMP	ALUM	-	-	-	-	-	5	_
OBD	36	84	1 3/4	В	ALUM	TEMP	ALLIM	-	-	-	-	-	5	
E0I5A														_
EOI5B							ļ					ļ <u>'</u>		_
E016		ļ					ļ							_
EOI7		ļ											ļ	
018A	36	84	1 3/4	A	SCW ·	- `	HM	ļ	-		-	- '	11	-
0188	36	84	1 3/4	Α	SCW	-	HM	<del>-</del>	-	-	-	-		_
018C	36	84	1 3/4	С	SCW	-	I-IM	-	-	-	24X24	-	7	-
0180	36	84	1 3/4	C	SCW ·	-	HM	<del>  -</del>	<del>  -</del>	<del>  -</del>	24X24	-	7	_
019A	36	84	1 3/4	A	SCW ·	-	HM	_	- /	-	-	-	Ю	_
0198	36	84	1 3/4	A	SCW	-	HM		- /	-	<del>-</del>   -		8	_
020A	36 36	84	13/4	A	SCW .	-	I-IM	-	<del>-</del>   -		<del>-</del>   <u>-</u>	3/4	6	_
O2I O22	36	84	1 3/4	D	SCW .	-	HM	_	-		12Xt2	_	6	_
023	36	84	1 3/4	D	SCW .	-	HM	-	-  -		12X12	-	6	_
023	36	84	1 3/4	D	SCW	-	HIM			_	12X12	-	1	_
025	36	84	1 3/4	D	SCW	_	HM	_	_		12X12	_	6	_
026	36	84	1 3/4	D	SCW	_	HM	<del>-</del>		-	12X12	<del>-</del>   _	6	
026 027A	40	90	1 3/4	В	ALUM	TEMP	ALUM	-	-   <u>-</u>	-	-		1	
027B	40	90	1 3/4	B	ALLM	TEMP	ALUM			<del>  -</del>		_	2	
028	36	84	1 3/4	A	SCW .	-	HM	-			_		Ю	_

POTTER DESIGN GROUP
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CHURCH

ADDITION AND REMODELING FOR: 4018 MINERAL POINT ROAD


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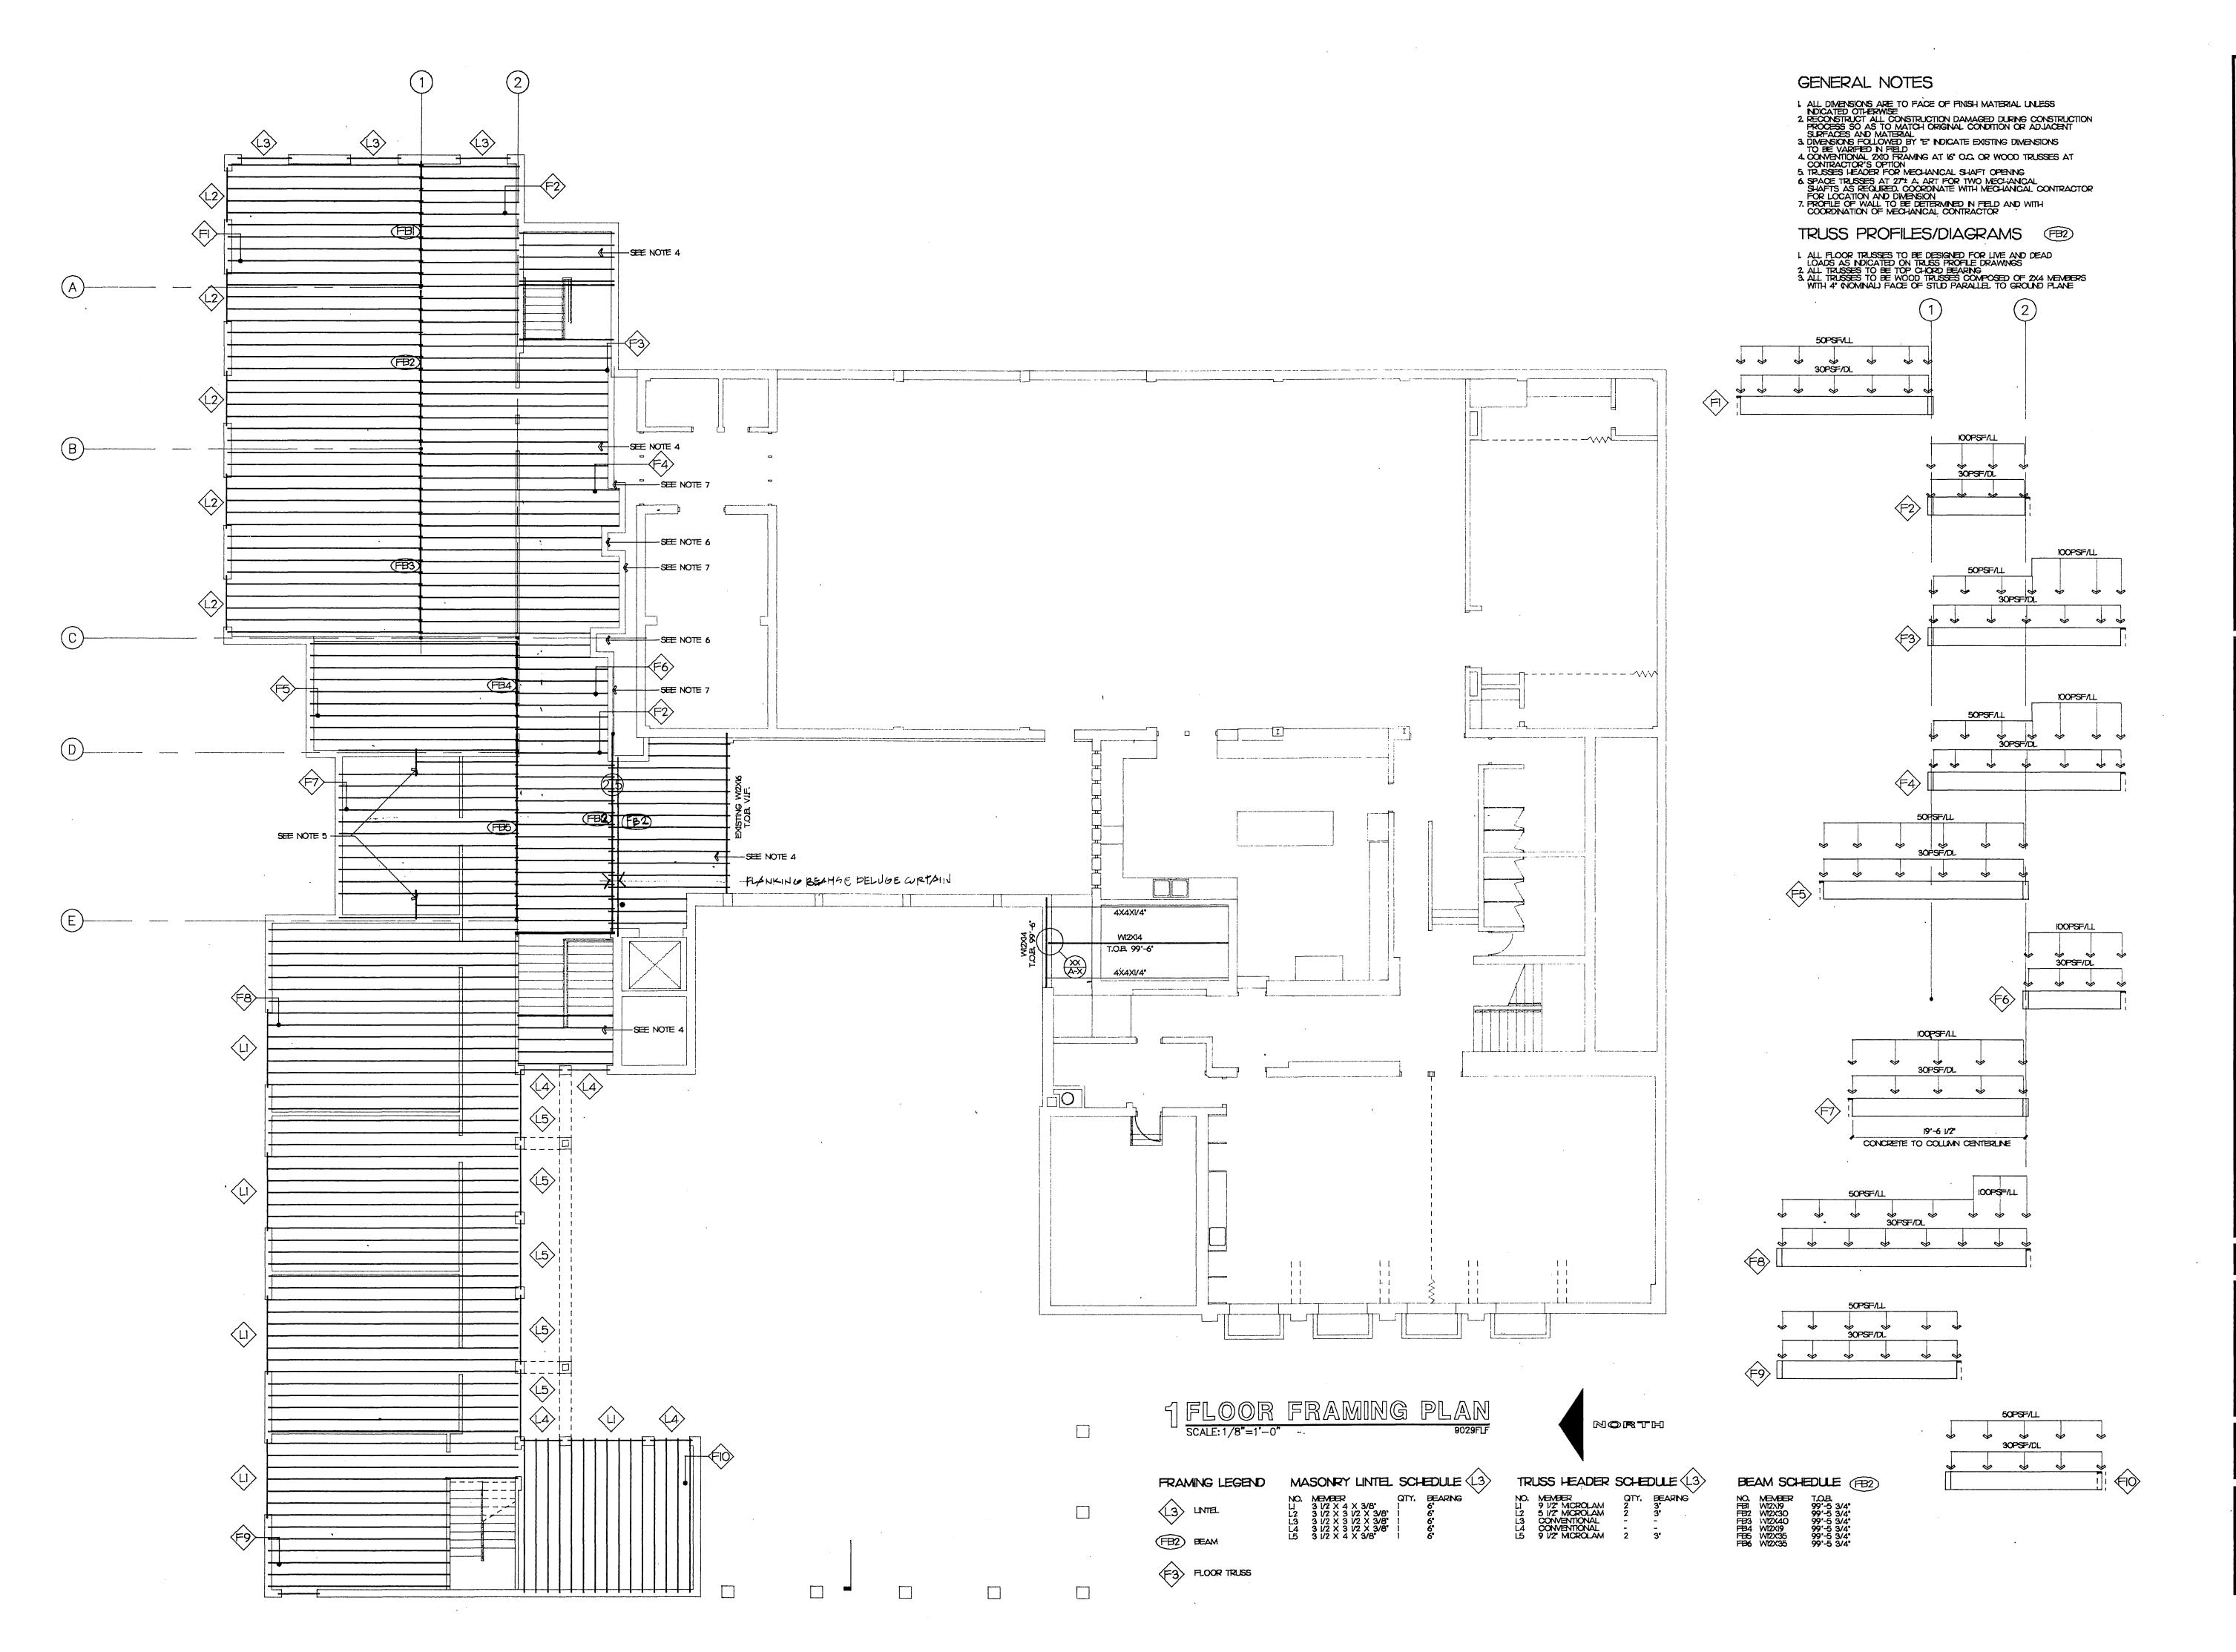
ADDITION AND REMODELING MOUNT OLIVE LUTHER,

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OUP **GB** DESIGN 


CHUR O ME ADDITION AND REMODELING OLIVE LUTHER MOUNT

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SHEET NO. **S-2** 

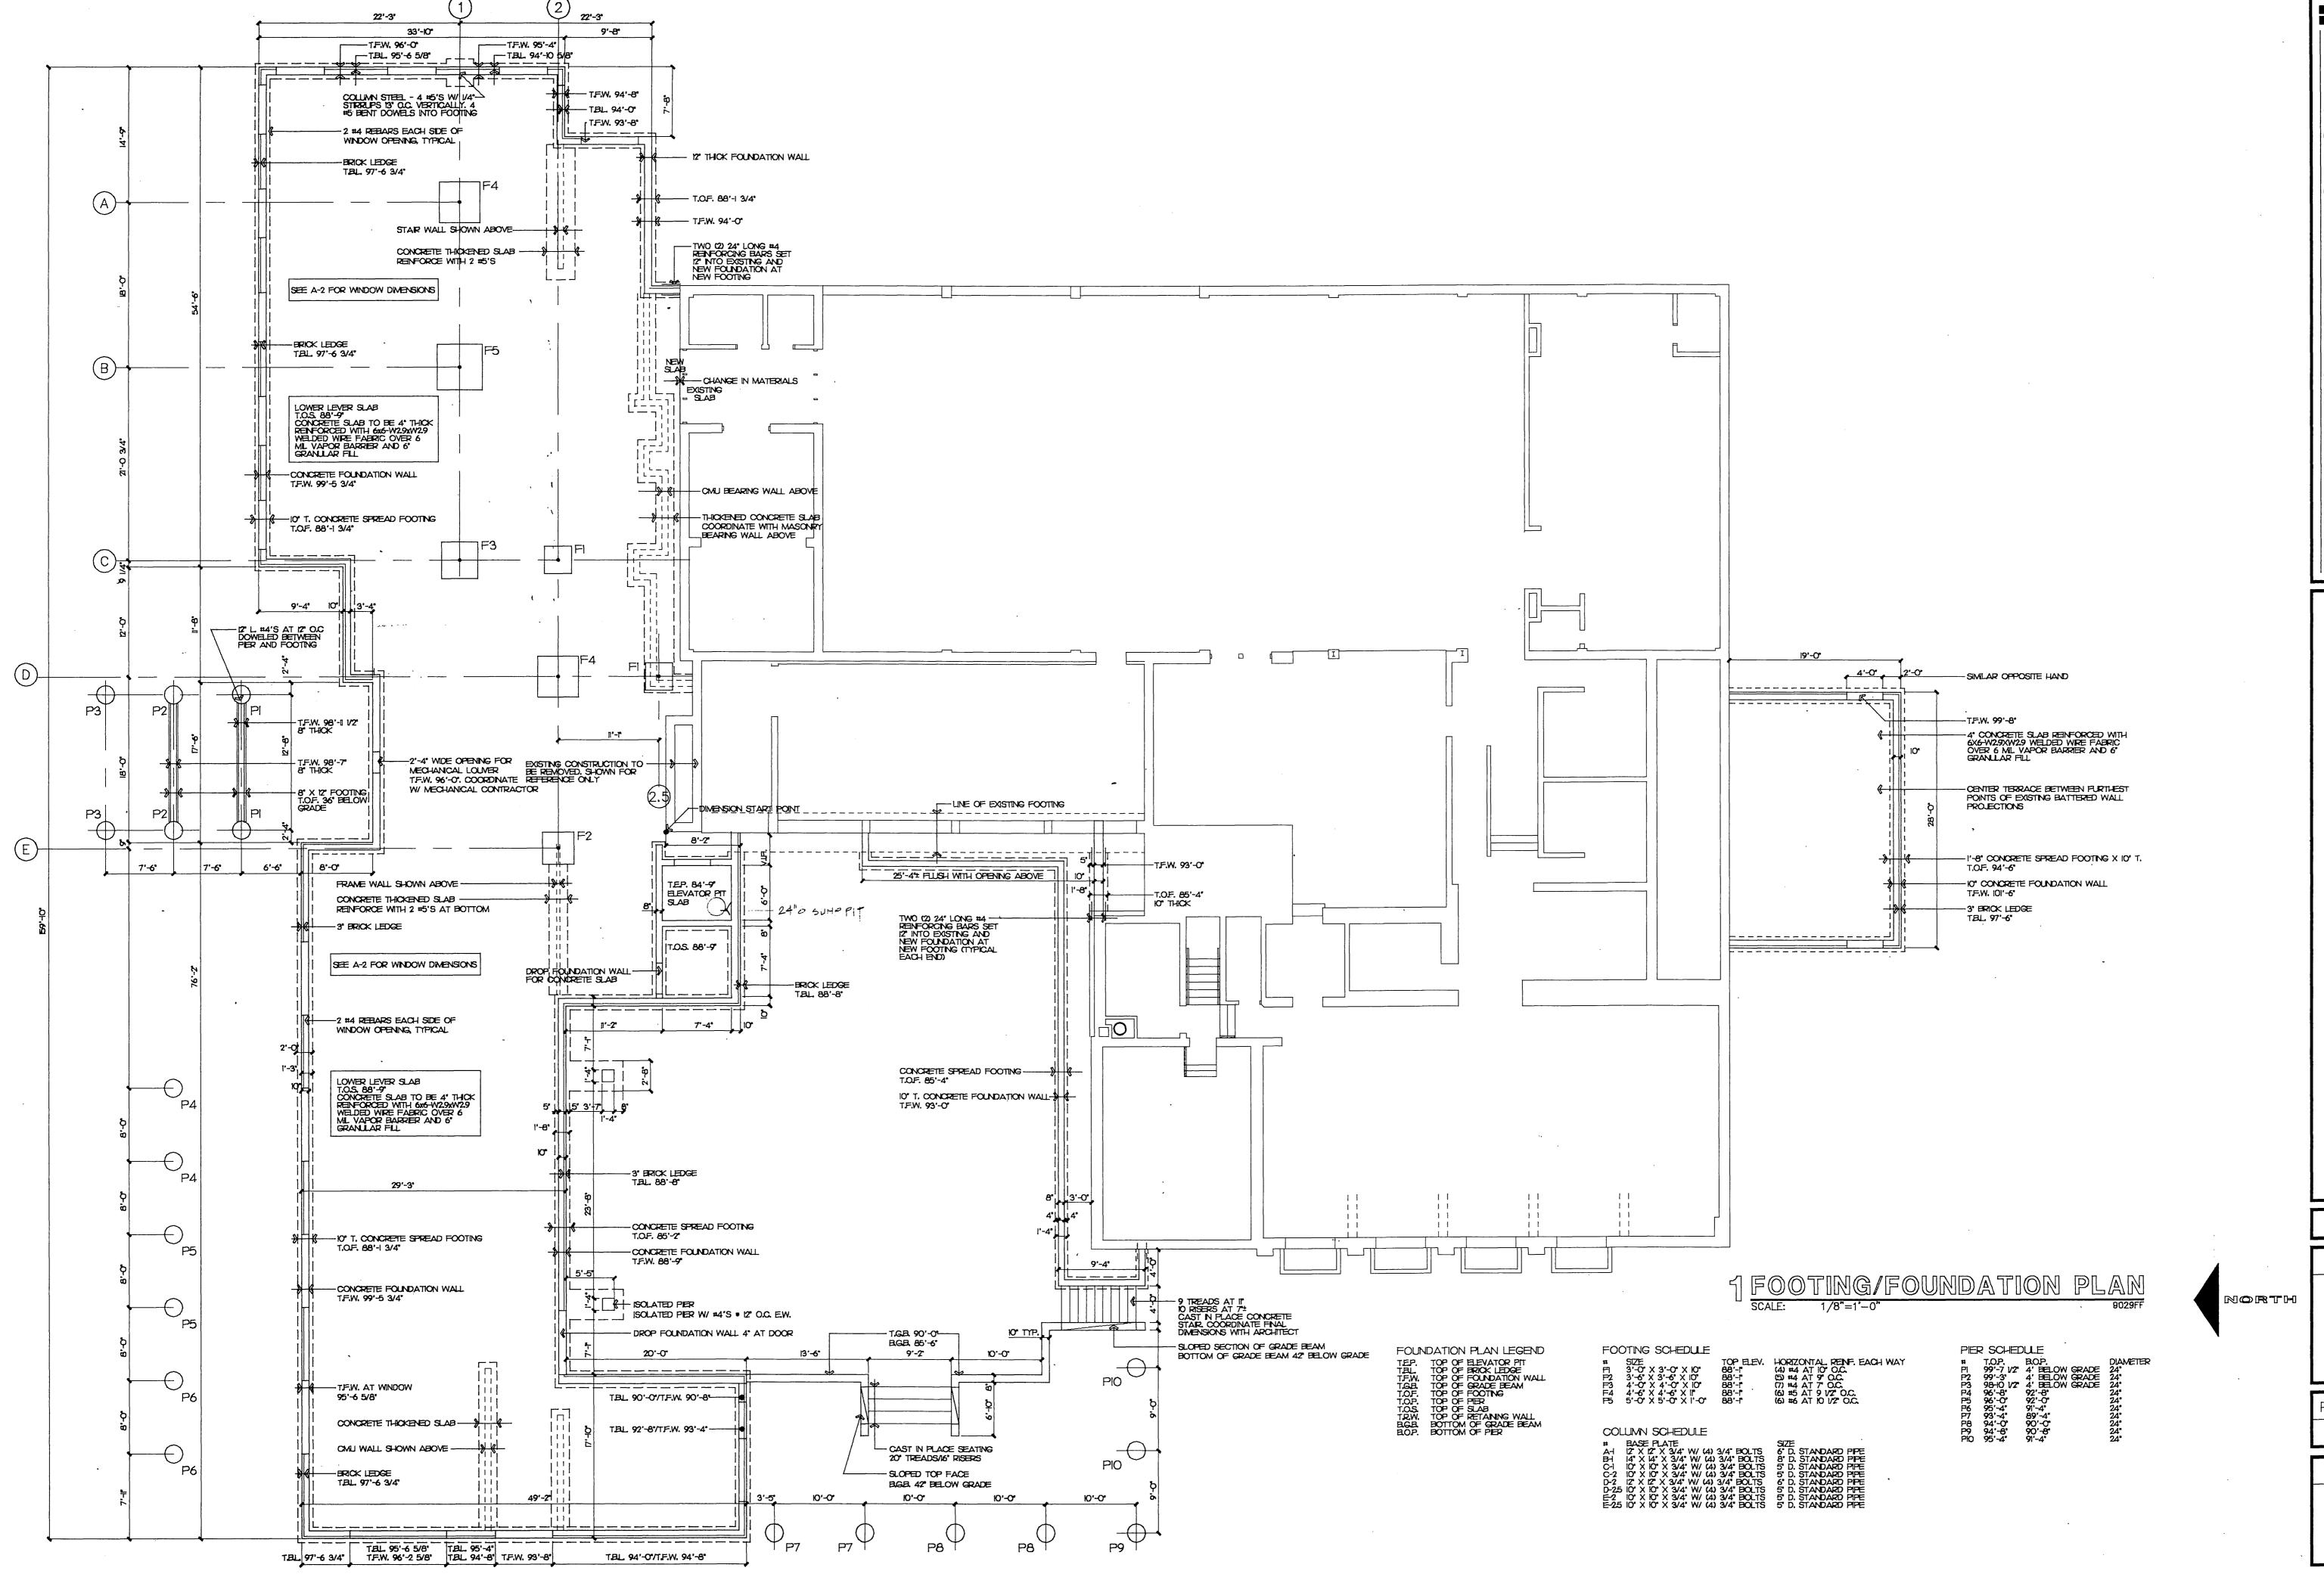

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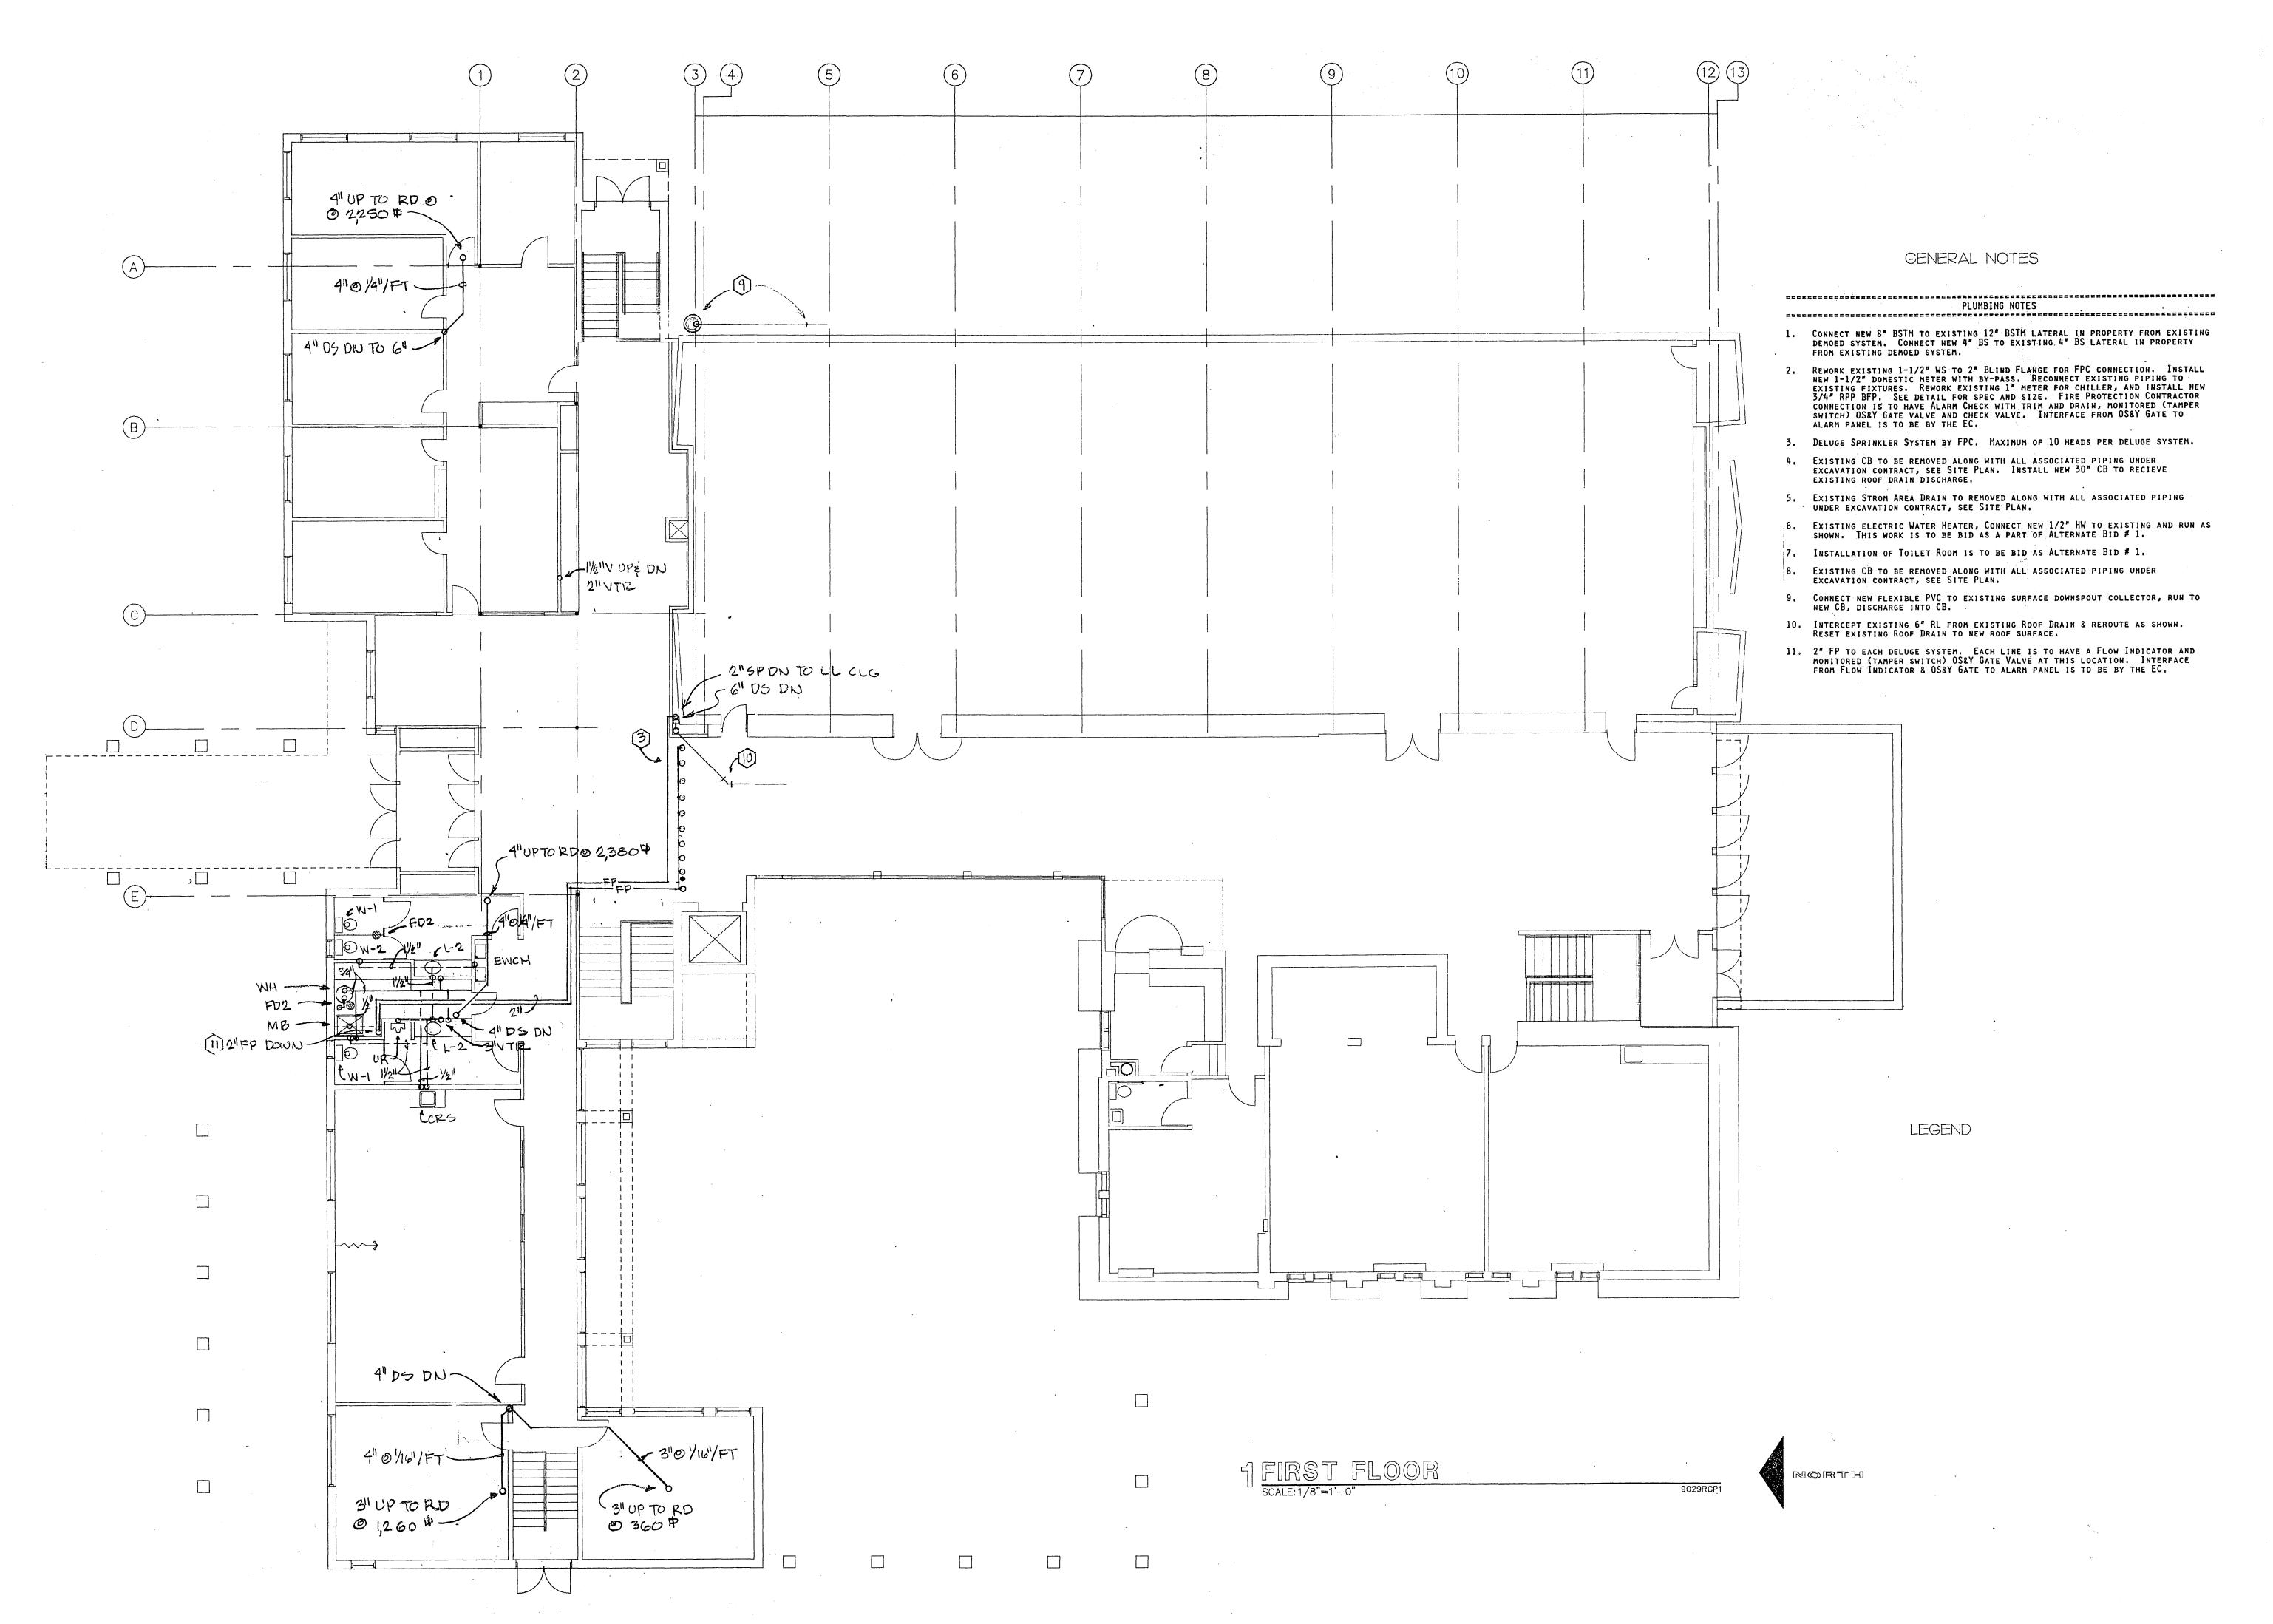
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ADDITION AND REMODELING FOR:
MOUNT OLIVE LUTHERAN GH
4018 MINERAL POINT ROAD MADISON, W 53705

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POTTER DESIGN G

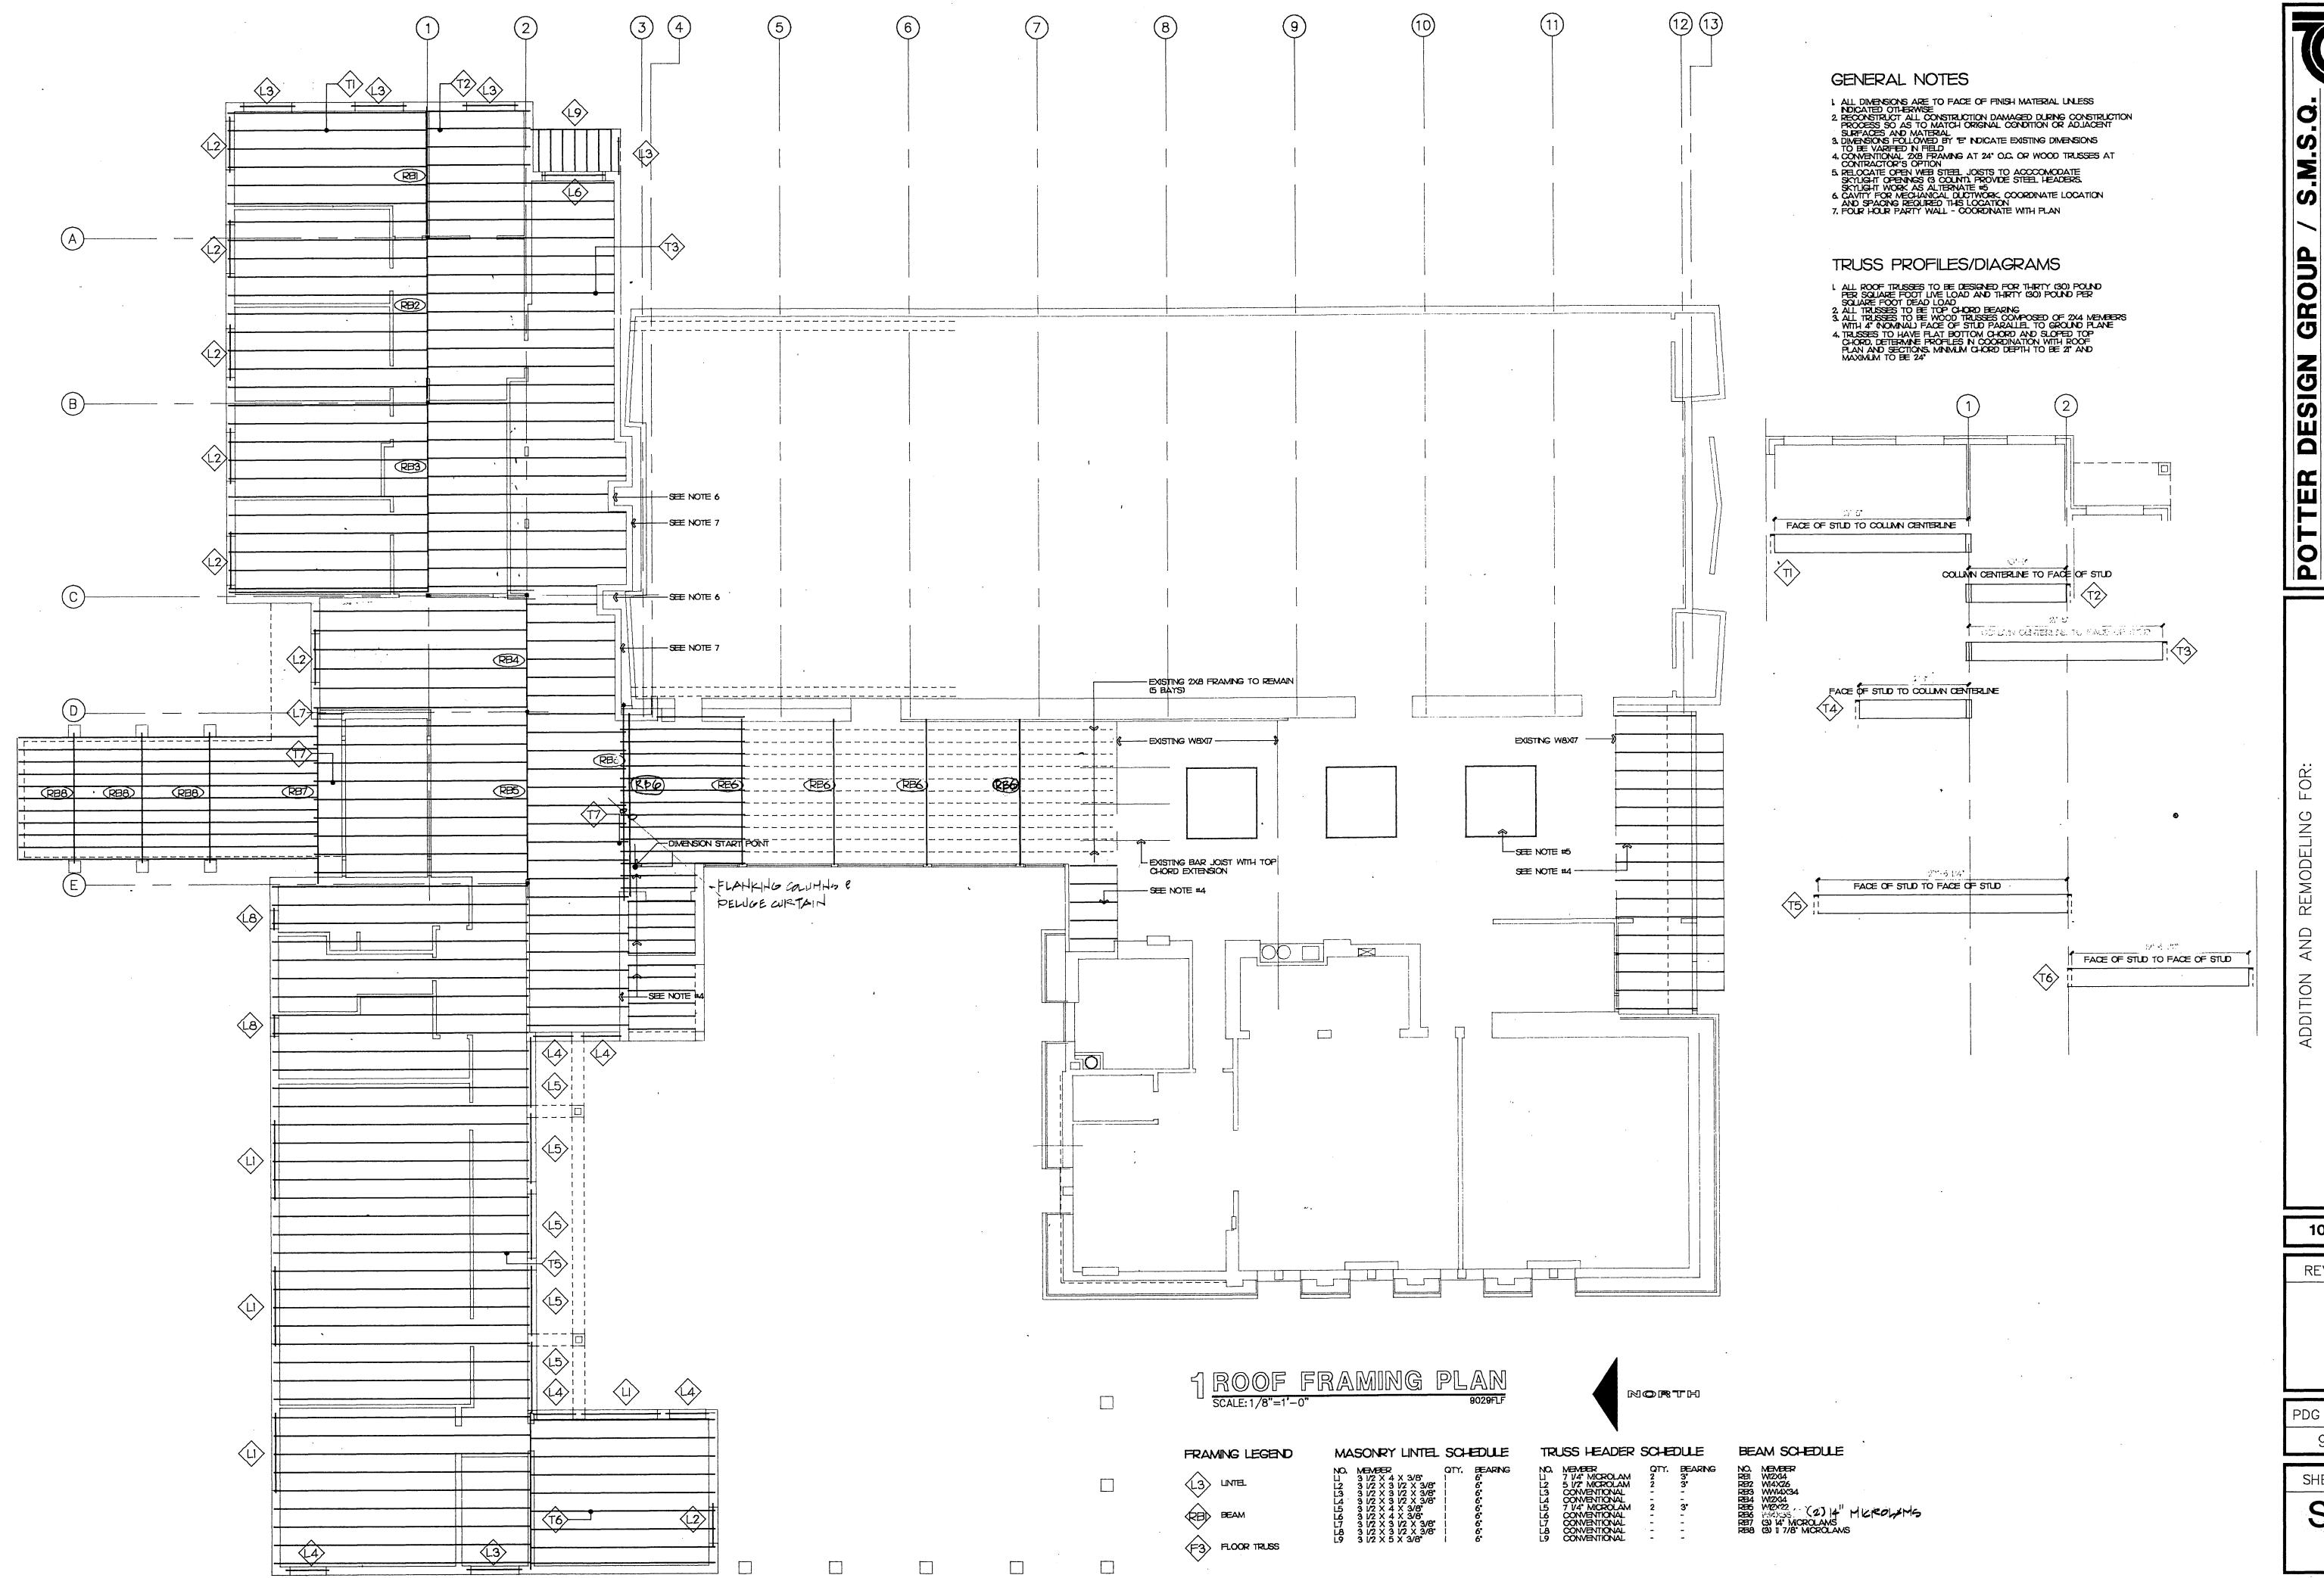AND MINERAL POINT ROAD MADISON WILL STOPE


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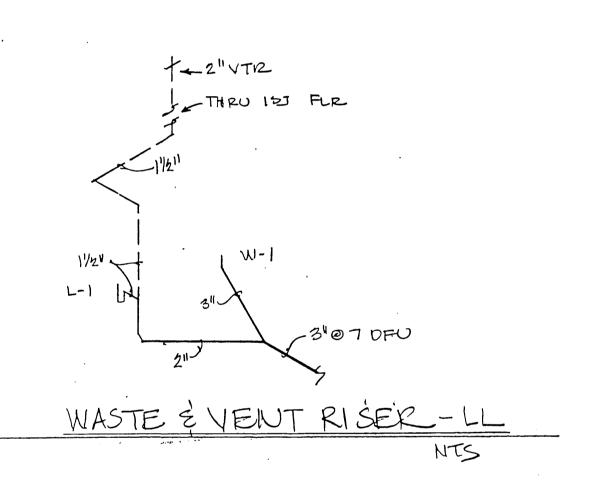
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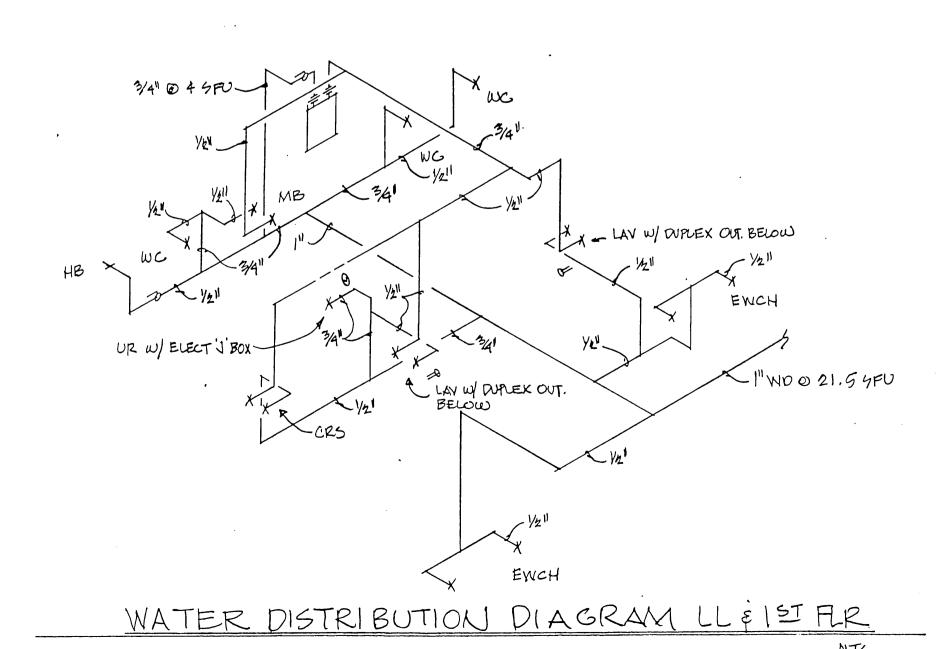
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SHEET NO. **P-2** 







PLUMBING CALCULATIONS, MT OLIVE LUTHERAN CHURCH, MADISON, WI

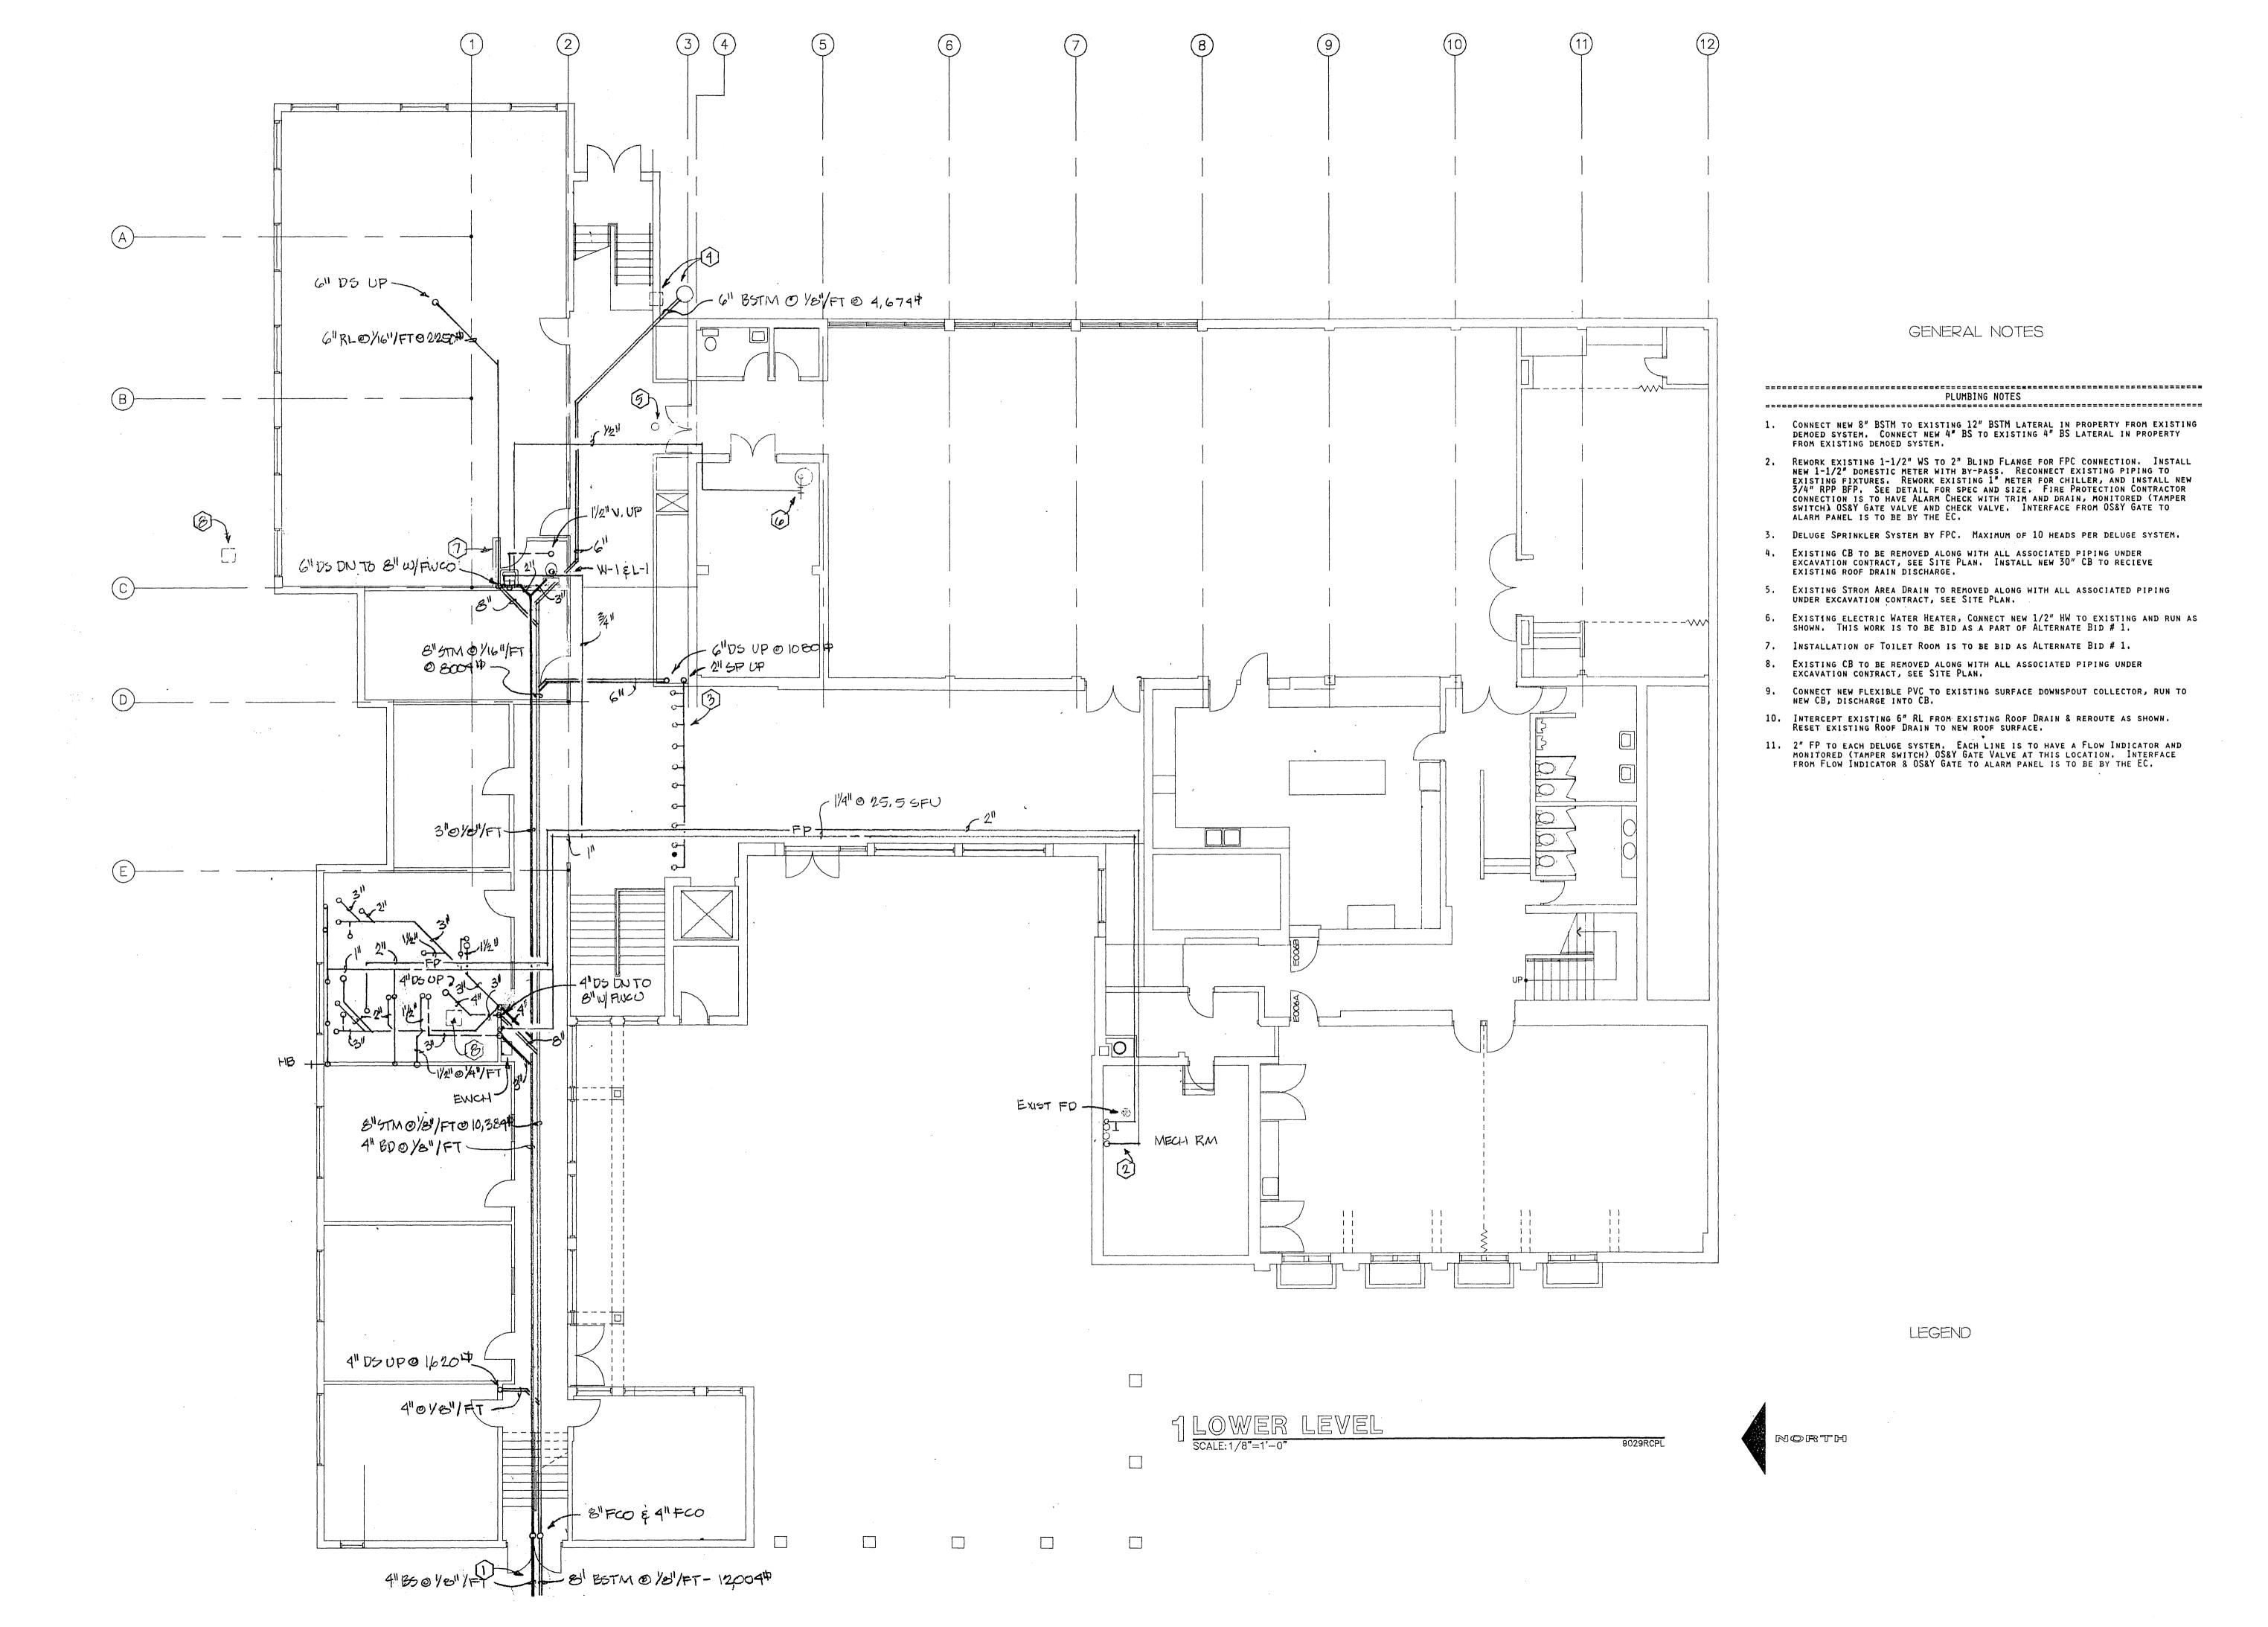SERVICE AND DISTRIBUTION DATA

1. BUILD DEMAND, GPM, 47 GPM.

2. Low pressure at HYDRANT, 65 PSI.

3. DIFFERENCE IN EL, HYDRANT TO METER, O'.

4. SIZE OF WATER METER, 1-1/2".

5. WS DLR, 145'.

PRESSURE AVAILABLE AFTER WATER METER

6. Pressure Loss due 70 WS, 1-1/2" a 47 GPM, 12 PSI/100' 145 X 12 ÷ 100 = 17.4 PSI.

7. PRESSURE LOSS DUE TO EL, O PSI.

8. PRESSURE LOSS DUE TO WATER METER, 1-1/2" AT 47 GPM = 5 PSI.

9. 65 - (17.4 + 5) = 42.6 PSI.

WATER DISTRIBUTION SYSTEM SIZING - WATER DISTRIBUTION & COLD WATER

A. PRESSURE AVAILABLE FOR UNIFORM LOSS, PSI/100', 9 PSI,

B. PRESSURE AVAILABLE AFTER METER, 42.6 PSI.

C. PRESSURE REQUIRED AT CONTROLLING FIXTURE, 15 PSI, URINAL.

D. PRESSURE LOSS DUE TO EL, 14' X .434 = 6.0 PSI.

E. PRESSURE LOSS DUE TO, DEVICES, O PSI.

F. WD DLR, 175' X 1.5 = 262.5' ELR.

G.  $46.2 - (15 + 6) \times 100 \div 262.5 = 8.22 \text{ PSI}/100'$ . WATER DISTRIBUTION SYSTEM SIZING EXISTING HOT WATER SYSTEM

A. PRESSURE AVAILABLE FOR UNIFORM LOSS, PSI/100', 10 PSI.

B. PRESSURE AVAILABLE AFTER WATER METER, 42.6 PSI.

C. PRESSURE REQUIRED AT CONTROLLING FIXTURE, 8 PSI.

D. PRESSURE LOSS DUE TO EL, 14' X .434 = 6.0 PSI.

E. PRESSURE LOSS DUE TO, WATER SOFTENER, 15 PSI.

F. WD DLR, 90' X 1.5 = 135' ELR.

6.  $42.6 - (8 + 6 + 15) \times 100 \div 135 = 10.0 \text{ PSI}/100'$ .

WATER DISTRIBUTION SYSTEM SIZING NEW HOT WATER

A. PRESSURE AVAILABLE FOR UNIFORM LOSS, PSI/100', 28 + PSI.

B. PRESSURE AVAILABLE AFTER WATER METER, 42.6 PSI. C. PRESSURE REQUIRED AT CONTROLLING FIXTURE, 20 PSI.

D. PRESSURE LOSS DUE TO EL, 14' X .434 = 6.0 PSI.


E. PRESSURE LOSS DUE TO, DEVICES, O PSI.

F. WD DLR,  $25' \times 1.5 = 37.5' \text{ ELR}$ .

G.  $46.2 - (8 + 6) \times 100 \div 37.5 = 76.2 \text{ PSI}/100'$ .

1/2" HW TO EXIST WH RECONN EXIST DOMESTIC WD-1/4" WID & 25,55FU CHILLER CON M UNION -NEW 1/2" METER Z EXIST I WM FOR CHILLER -NEW 34" RP BFP W/ DRIP TO EXIST FD IN ROOM -NEW 21 BUND FLANGE 0 47 6PM

WATER DISTRIBUTION DIAGRAM - LL

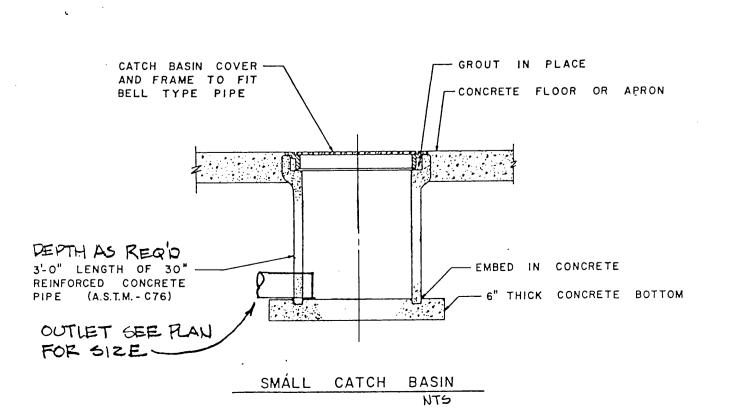


ABBREVIATION DESCRIPTION SCHEDULE -----

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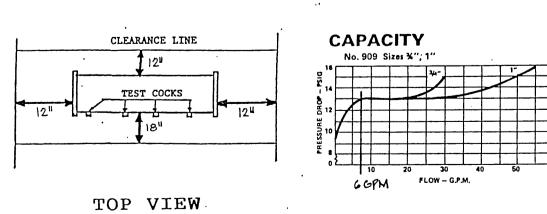
ABBREVIATION SANITARY BUILDING DRAIN OR SEWER STORM BUILDING DRAIN OR SEWER BD - BS STM - BSTM WATER SERVICE
WATER SERVICE/FIRE PROTECTION COMBINATION
CATCH BASIN (STORM) WS WS/FP VENT
SANITARY SEWER SUSPENDED OR STACK
SUSPENDED ROOF LEADER (STORM)
WATER DISTRIBUTION PIPING, SUSPENDED OR BURIED
COLD WATER DISTRIBUTION PIPING, SUSPENDED OR BURIED
HOT WATER DISTRIBUTION PIPING, SUSPENDED OR BURIED
WATER CLOSET (TYPE DESIGNATION)
LAVATORY (TYPE DESIGNATION)
URINAL (TYPE DESIGNATION)
SINK (TYPE DESIGNATION) SINK (TYPE DESIGNATION) CLASS ROOM SINK
COMB. HANDICAP & REGULAR HT ELECTRIC WATER COOLERS COMB. HANDICAP & REGULAR HI ELECTRIC WATER COUL
MOP BASIN
HOSE BIBB
WATER HEATER (TYPE DESIGNATION)
TEMPERATURE & PRESSURE RELIEF VALVE DISCHARGE
FLOOR DRAIN (WITH SPECIALITIES)
REDUCED PRESSURE PRINCIPLE BACK FLOW PREVENTOR WH(-1) T&P RVD CO FCO FWCO ABV FINISHED FLOOR CLEANOUT FINISHED WALL CLEANOUT BALL VALVE, (SHUT OFF) FLOOR ABOVE FINISHED FLOOR ABOVE FINISHED GRADE DOWNSPOUT PLUMBING CONTRACTOR GENERAL CONTRACTOR GENERAL CONTRACTOR
ELECTRICAL CONTRACTOR
HEATING, VENTILATING, & AIR CONDICTIONING CONTRACTOR
FIRE PROTECTION CONTRACTOR
POOL EQUIPMENT CONTRACTOR
KITCHEN EQUIPMENT CONTRACTOR
BAR EQUIPMENT CONTRACTOR
SECTION SPECIFICATION
ARCHITECT/ENGINEER
ELVATION
SUPPLY FIXTURE UNITS
DRAINAGE FIXTURE UNITS
WASTE AND VENT RISER
DOES NOT APPLY.
NOT TO SCALE
BRANCH INTERVAL AT WASTE AND VENT RISER
WATER DISTRIBUTION RISER
VENT HEADER OR STACK
VENT THROUGH ROOF VENT THROUGH ROOF GALLONS PER MINUTE PRESSURE, POUNDS PER SQUARE INCH - GAUGE PRESSURE, POUNDS PER SQUARE INCH MANHOLE BIT PVMT BITUMINOUS PAVEMENT BACKFILL FIRE DEPT. CONNECTION FIRE HYDRANT

UTILITY WATER MAIN

UTILITY SANITARY MAIN
UTILITY STORM MAIN
STANDPIPE (FIRE PROTECTION)

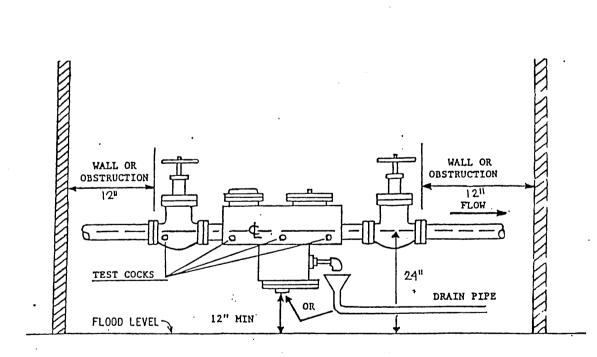

FRONT VIEW



WATTS No. 909-3/4", BFP will loss 12.5 PSI @ 5 GPM, & 13 PSI from 8 GPM to 20 GPM.

REDUCED PRESSURE ZONE BACKFLOW PREVENTER DETAIL



SIGN GROUP POTTER DE

> UTHER. MOUNT

REMODELING

AND

ADDITION

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SHEET NO. P-3



GROUP DESIGN POTTER CHURCH ND REMODELING FOR:

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MOUNT

OLIVE


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SHEET NO. HV-1



GR	ILL	E, R	EGIS	TER, C	) LEE	USE	CR SCI	EDULE	
MARK	MANUF	ACTURER	MODEL	MOUNTING	ŃĊ	PD	DUTY	REMARKS OR ACCESSORIES	
<u></u>	LIKG	UIPE	13-0B	GYP BD CELLUG			SUPPLY	DVG LUDICATES DIRECTION OF BLADE DAMPER, 50-ED, W	· · · · · · · · · · · · · · · · · · ·
占			VH-0B	PUCT			SUPPLY	WHITE	
6		:	KA-OB	Wall			RETURN	WHITE	
D			KA-AG	GYP BP GEILING			TRANSFER	WHITE	
DG		<b>b</b>	DG-3	DOOR			TRAUSFER	SUMINOM	
				The state of the s					

	usc	ELL	ANE	ous E	GUIPMENT SCHEDULE
NO.	EQUIF	PMENT	MANUE	'ACTURER	DESCRIPTION
ı		TKIC HEATEK	MAK	KEL	1000 WATT, 208 V-10, MODEL 3420, THEMAL OVERLOAD, HIL LABEL INTEGRAL STAT, SEMI-RECESSED
2		•			SAME AS 1
3		, 1			THEGRAL STAT, SEMIL RECESSED - 2 UNITS REDID !
4		`\.			
5/6	4	,			ZUNITS REP'D
B	ELEC	TRIC	-	0	MARKELL MODEL W- 8111, 1690 POINTED SCHHINLY, 4' ELEMENT LELETH, CASINET AS NOTED IN SUD COPS. CABINET 5/2" HIGH, 3/2" DEEP, STAT
WL	Wall 1	OWEK,	VENT	Propiets:	MODEL 440, FLAKE, BIRD SCREEN 1/2×1/2", STANDARD MILL FINISH, PAINT BY OTHERS.
A	EVECT		Mak	KEL	MARKEL MODEL 2500, 208 V, I W/INTEGRAL STAT (ELEVATOR EQUIP. RM)
1	HUMIDI	FIER	KE SEA	SECHI BOUCTS	MODEL 110 W RETURN DUT HUMIDISTAT, SODDLE VALVE, 120V . 75 AMP TUSTAND DRAIN TO FUR DRAIN - FURNACE/COIL () INSTALL WATER
2	HUMIE	AFIEK -		arch wars	SAME AS () FURNACE/COIL (2) INSTALL WATER

		VODE	OFM	E-V-	EVAP.	COIL	HEATING		ELI	ECTRIC	AL	REMARKS
NO.	MFG'R	MODEL	CFM	EXT.	MODEL	EAT	IN	OUT	HP	VOLTS	0	
1	CARRIER	585X 100 LG	1600	.7"	23 RU 060	80%	110	102	3/4	115	1	BOTOH K.A.
2		585X 100 LG	1955	-7"	28 Kil		i		3/4	115	1	BOTTON K.A
3		585×	1955	.7"	28KI				3/4	115	!	BOTTOM RA
4	40	585X	1955	-7 <sup>n</sup>	28RJ 060	cher.	9	P	3/4	115	1	BOTTOM KA

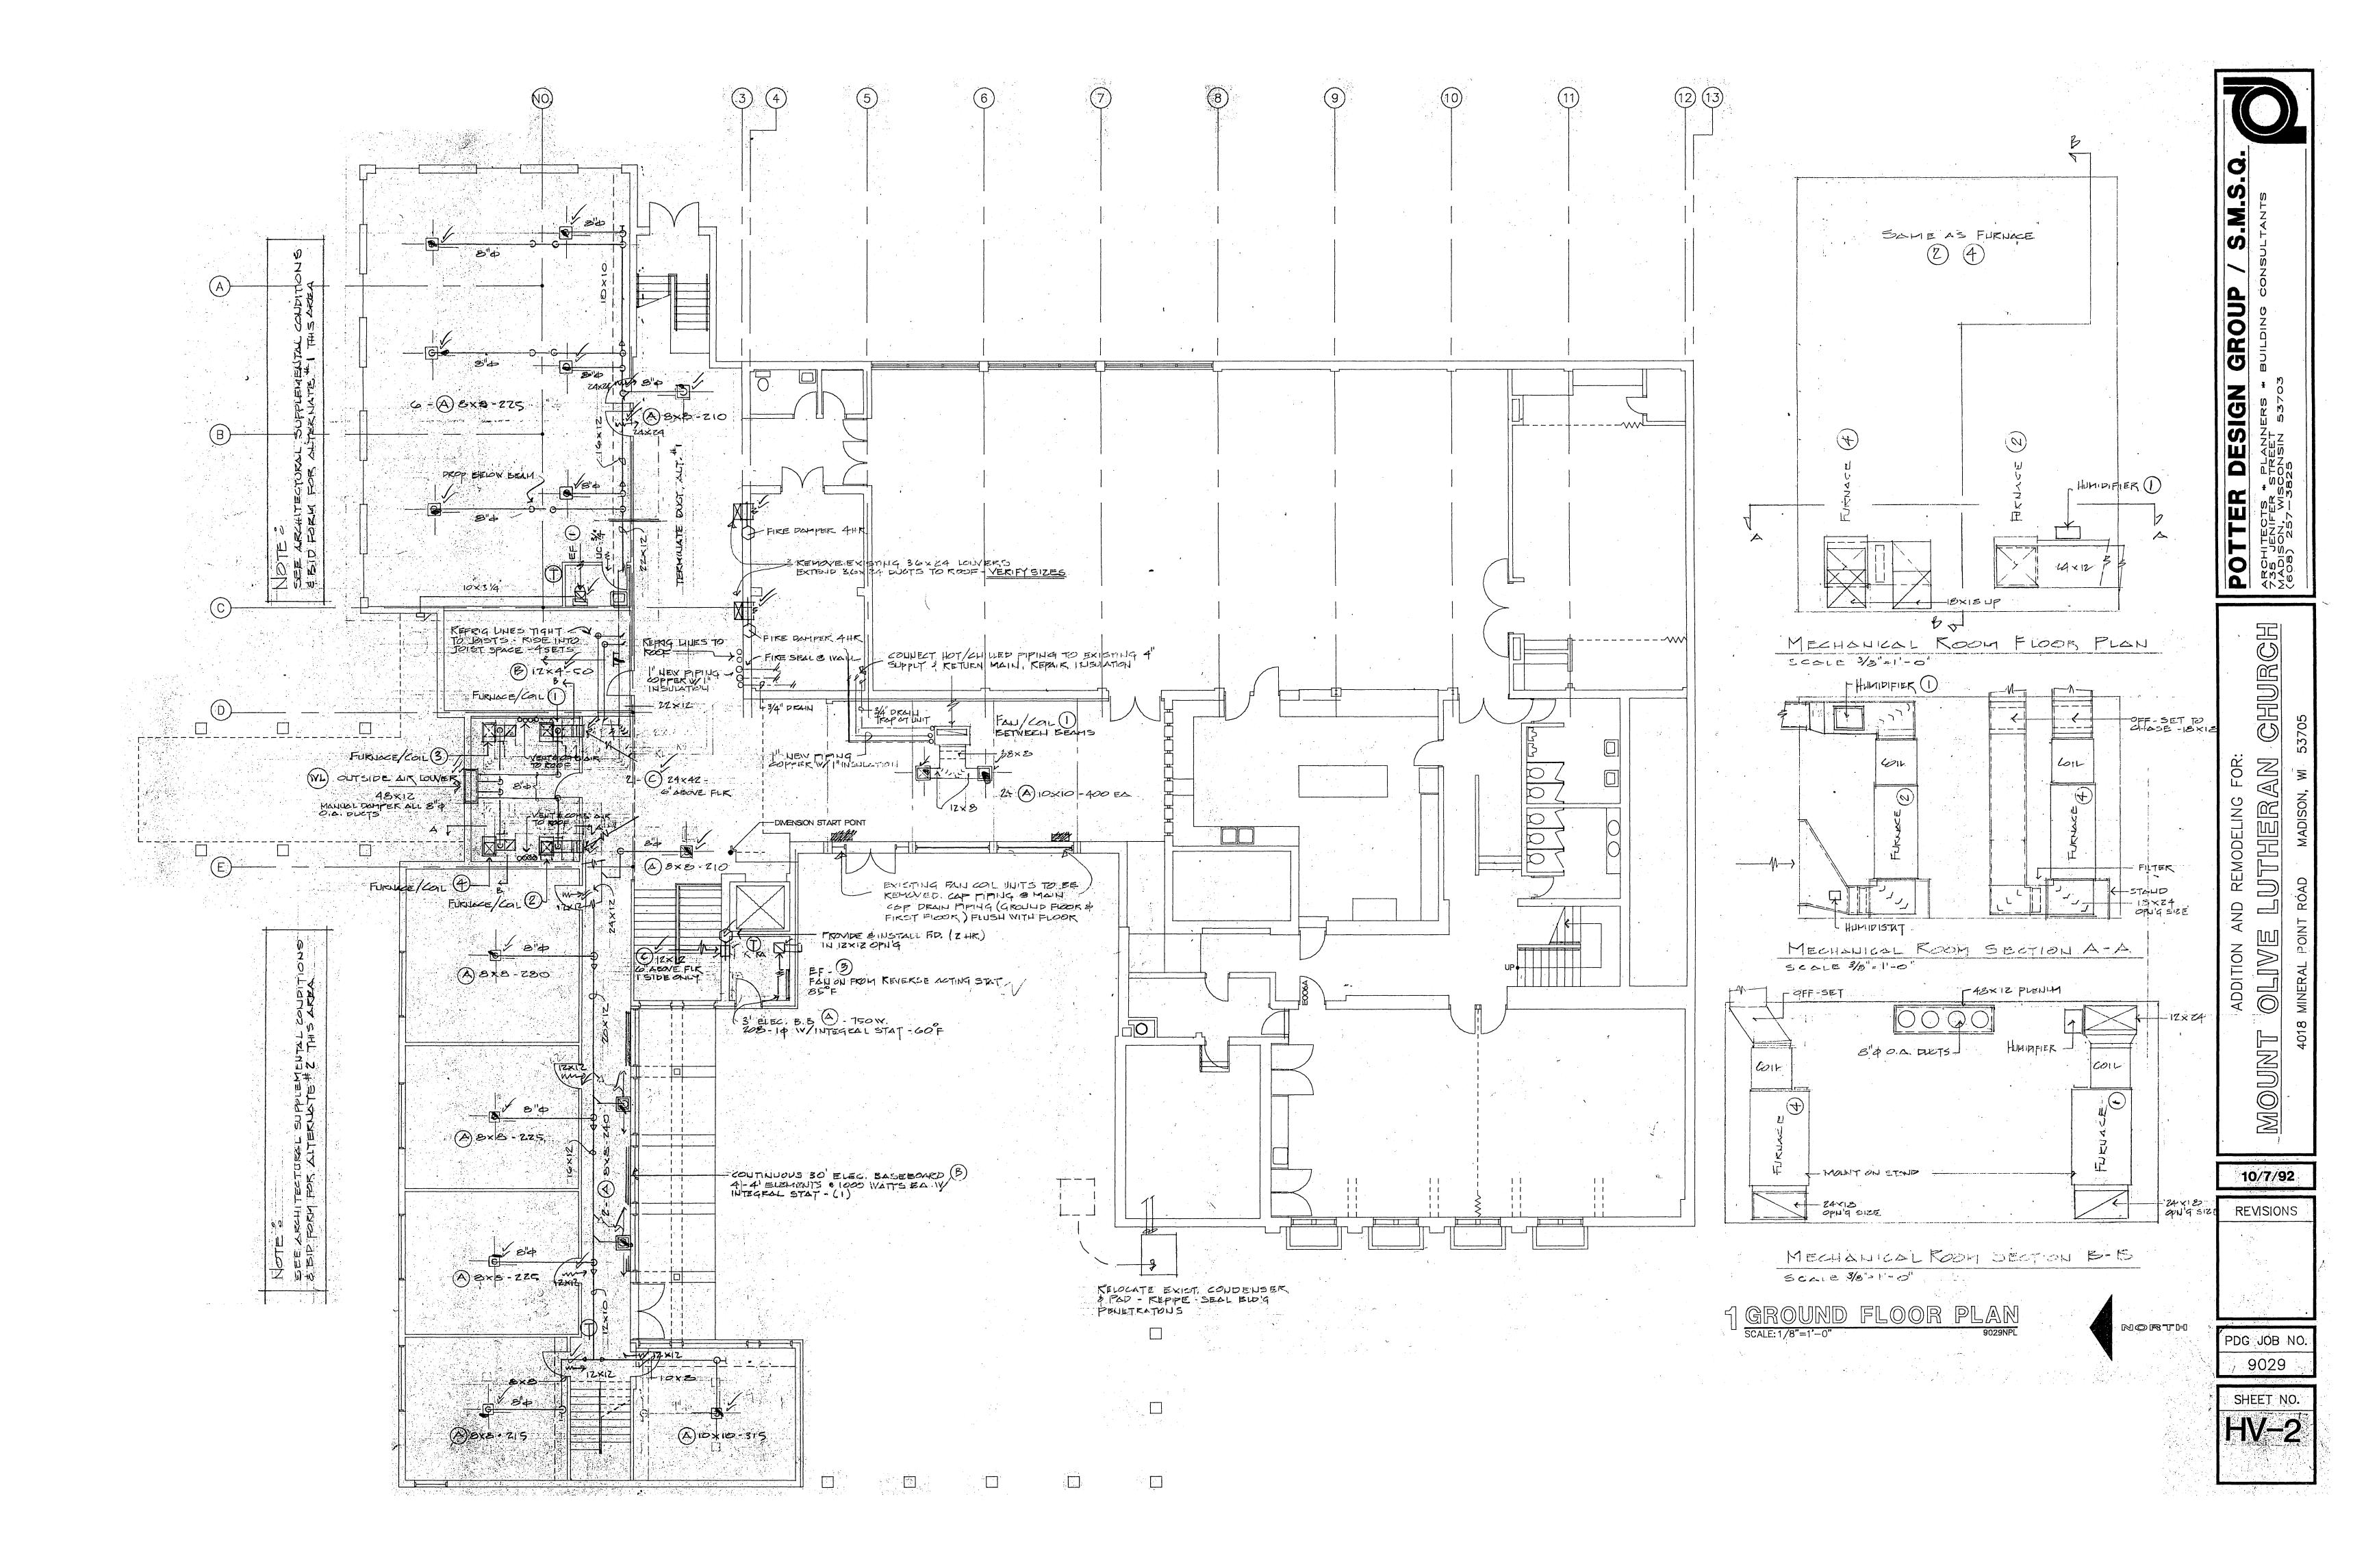THEROSTATS - HONETWELL T-7200 W/AUX, RELAY FOR EF-Z

				REFR		• • • • • • • • • • • • • • • • • • • •			MIN		ELI	ECTR	IC	AL .	REMARKS
NO	MANUFACTURER	MODEL	MBH	TEMP		LOAD STEPS		CPM	OA TEMP	EER	MCA	MFA	Ø	VOLT	AND ACCESSORIES
	CSERIER	55TKB	54	450	1	OU/ OFF	95	2900	,	Ю	23.2	35	3	208/	PROVIDE PAD, PITCH PODICET FOR REFOC. LINES
2															
3															
4	a/	d	OP.	9	*	4	*	-10		1	4	ميلا		4	<b>*</b>

BOLATON PAD-ALL UNITS

					60	200	ARRG'T	CTACC		ECTRIC	STARTER	REMARKS
NO.	MANUFACTURER	MODEL	TYPE	CFM	SP	RFA	ARRU 1	CLASS	HP	Ø VOL		CETAROS
	EROSIU	360	clq	100	1/0	1200	HOME	I PLICE	6T	1 115	N/A	OH W/LAHT SWITCH
V	PEHN	AB-10	Roof	1000	1/4"	1600	PRV	NA	1/4.	1115	ELEC.	OH W/FURNACE "3 FAN EURS, BDD, BG, DISCONNECT
2	BROAL	361	CLG	160	1/5	1600	HOKIZ	NA	110	115	NA	FURNIOH & INSTALL REVENCE ACTING STAT - 85°F

		Total of the Committee	Printed to the state of the sta	and the second of the second	15	Trides (Commence of the Commence of the Commen		
NO.	MANUFACTURER	MODEL	TYPE	THROAT*	CFM	MATERIAL	FREE AREA % OF THROAT AREA	REMARKS AND ACCESSORIES
1	PEUU VEUTINOK	DRC	KOOF	3.69	2400	MHNIMINA	100%	PROVIDE CURE & IZ", SIKD SCREELL, 20 x 20 KOOF OPN'G, 20 X 20 DUCT
Z	+	1		1	7.			<b>\</b>

	FAN CO	IL S	CHE	DUL	.E													
						EL	EC:	TRIC	2177			С	00L 11	<b>VG</b>			HEATING	
NO.	MANUFACTURER	MODEL	CFM	SP	ARRG'T	HP	ø	VOLT	SIZE	EAT	TC	sc	EWT	GPM	ROWS	WPD'	MBH	EWT
	CORRIER	42CK	200	.05	HORIZ.	765 W	1	115	08	50%	22.6	16.9	45°	4.6	3		26.9	180
2	J	<u> </u>				1			T					+	1		46.9	1

S.M.S.Q.

ADDITION AND REMODELING FOR: MIOUNT OLIVE LUTHERAN 4018 MINERAL POINT ROAD MADISON, W E

10/7/92

REVISIONS

PDG JOB NO 9029

MOUNT

AND REMODELING

ADDITION

MTNEF.

OLIVE


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ADDITION AND REMODELING FOR:
MOUNT OLIVE LUTHERAN GHURGH
4018 MINERAL POINT ROAD MADISON, WI 53705

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REVISIONS

PDG JOB NO. 9029

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S.M.S.Q.

DESIGN GROUP

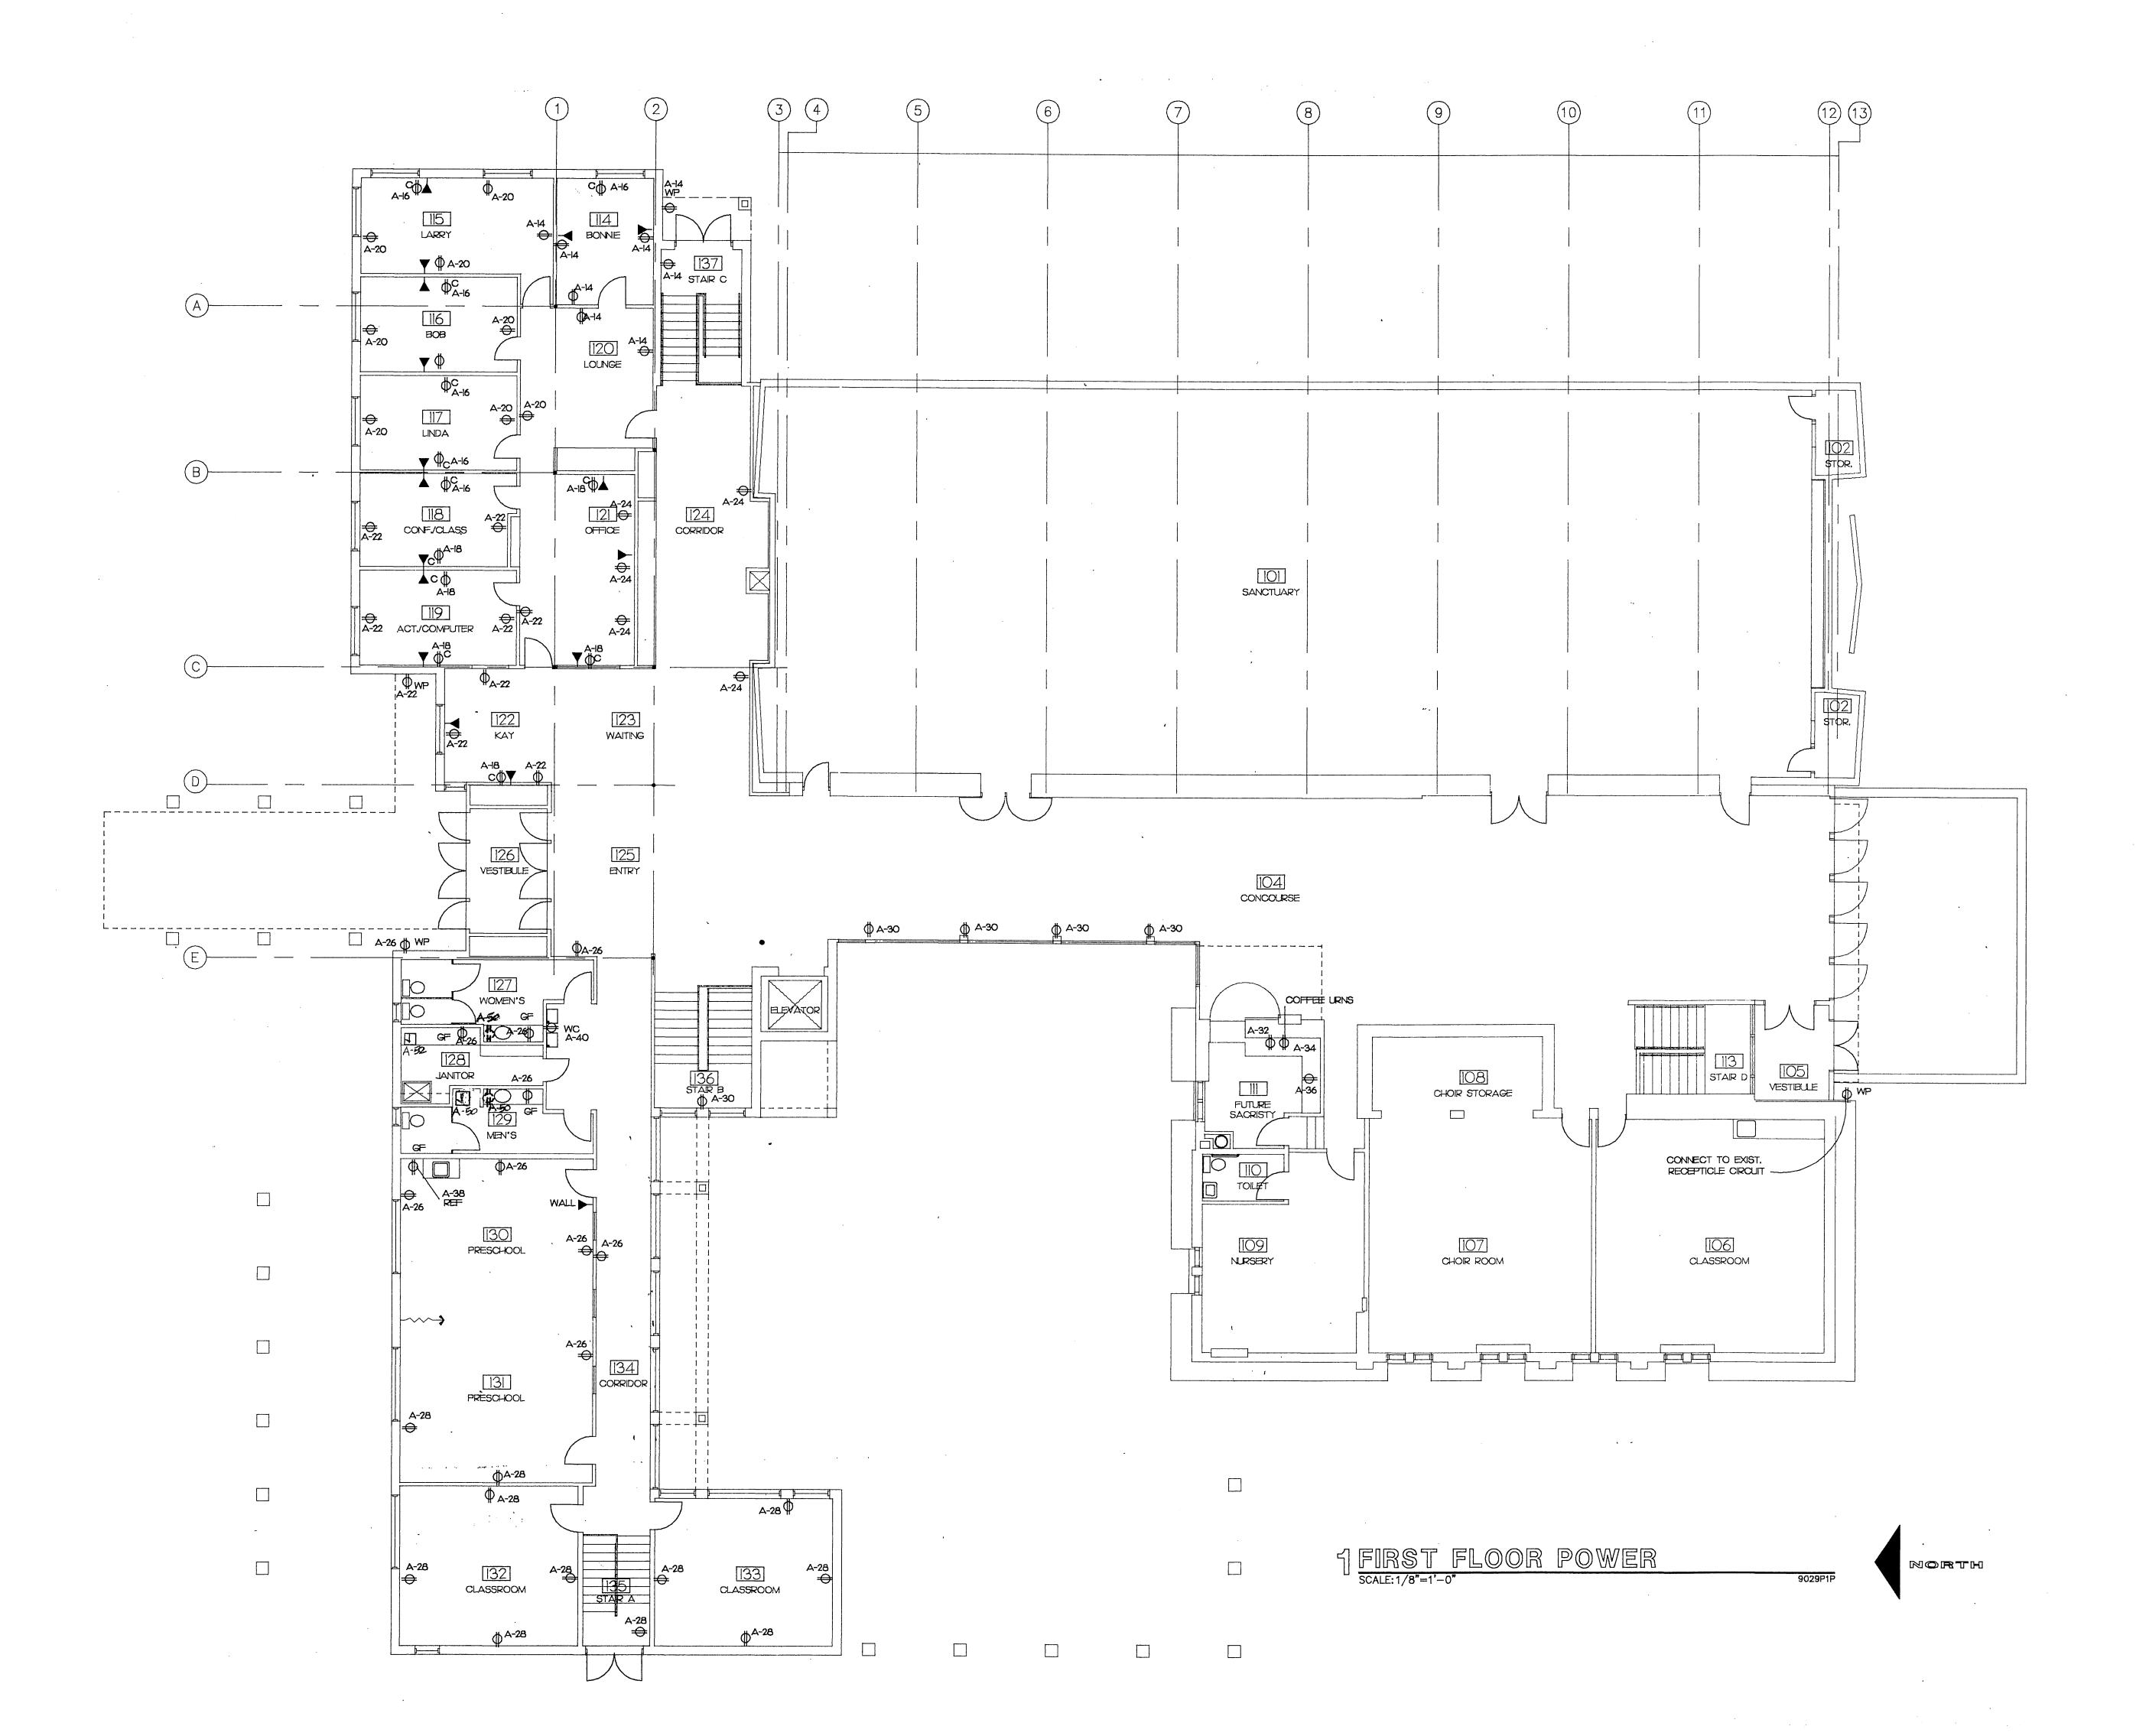
POTTER


ADDITION AND REMODELING FOR:
MOUNT OLIVE LUTHERAN CHURCH

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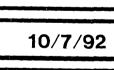


MOOM 10/7/92 FRONT RING & COVER PL. ONLY ☐<del>-69</del> DIMMER SWITCH REVISIONS LIGHT FIXTURE-PENDANT OR SURFACE MTD. (C) CLOCK OUTLET BUZZER ABOVE COUNTER OR AT SWITCH HEIGHT ISOLATED GROUND C CAMERA OUTLET R LIGHT FIXTURE-RECESSED C. - SWITCH WITH PILOT LIGHT (F) FAN OUTLET PUSHBUTTON AFF ABOVE FINISH FLOOR NIGHT LIGHT — LIGHT FIXTURE-WALL MTD. ¥ ← KEY OPERATED SWITCH D ELECTRIC DOOR OPENER J JUNCTION BOX 2X4 FLUORESCENT LIGHT FIXTURE PS PULL SWITCH EXIT LIGHT-PENDANT OR SURFACE MITD. BT BELL-RINGING TRANSFORMER SWITCH WITH DUPLEX OUTLET DUPLEX OUTLET FOR COMPUTER 4' FLUORESCENT LIGHT FIXTURE REF REFRIGERATOR CONDENSING UNIT FLOOR TELEPHONE OUTLET DUPLEX RECEPTACLE OUTLET FIRE ALARM PULL STATION 6' FLUORESCENT LIGHT FIXTURE EXHAUST FAN TS TIME SWITCH M MOTOR OUTLET-WIRE DIRECT F FIRE ALARM HORN ₹ WEATHERPROOF DUPLEX OUTLET ELECTRICAL PANEL 12,6 NO. INDICATES CIRCUIT LEG-LETTER INDICATES SWITCH LEG 9' FLUORESCENT LIGHT FIXTURE EWC ELECTRIC WATER COOLER CH CHIME DISCONNECT SWITCH (T) THERMOSTAT QUADRUPLEX OUTLET POLE MOUNTED FIXTURE—SINGLE HEAD EWH ELECTRIC WATER HEATER conduit/wring above ceiling BELL SINGLE POLE SWITCH FLOOR MTD. DUPLEX RECEPTACLE (S) SPEAKER EMERGENCY LIGHTING FIXTURE existing — to remain OR IN WALL PDG JOB NO THREE WAY SWITCH MIC FLOOR RECEPTACLE W/
COVER PLATE & CARPET TRIM OUTLET WITH FINAL CONNECTION TO EQUIPMENT ELECTRICAL SERVICE CONDUIT/WIRING (D) HEAT DETECTOR 1,F2, LIGHTING FIXTURE CODE NO.— SEE LIGHTING FIXTURE SCHEDULE CONDUIT/WIRING IN OR UNDER FLOOR COMPUTER OUTLET 4+0 FOUR WAY SWITCH 9029 CONDUIT/MRING EXPOSED ON WALL/CEILING SINGLE GANG BOX FOR WALLPL FUSETRON BOX COVER UNIT GFI GROUND-FAULT CIRCUIT-INTERRUPTER FLOOR COMPUTER OUTLET ELECTRICAL EQUIPMENT CONNECTION A SINGLE GANG BOX FOR WALL PL. W/RCA JACK FOR TV AUDIO FEED SHEET NO. TO SOUND SYSTEM SINGLE GANG BOX FOR WIRE TO EQUIP SINGLE GANG PULL BOX & PL.

CHURCH

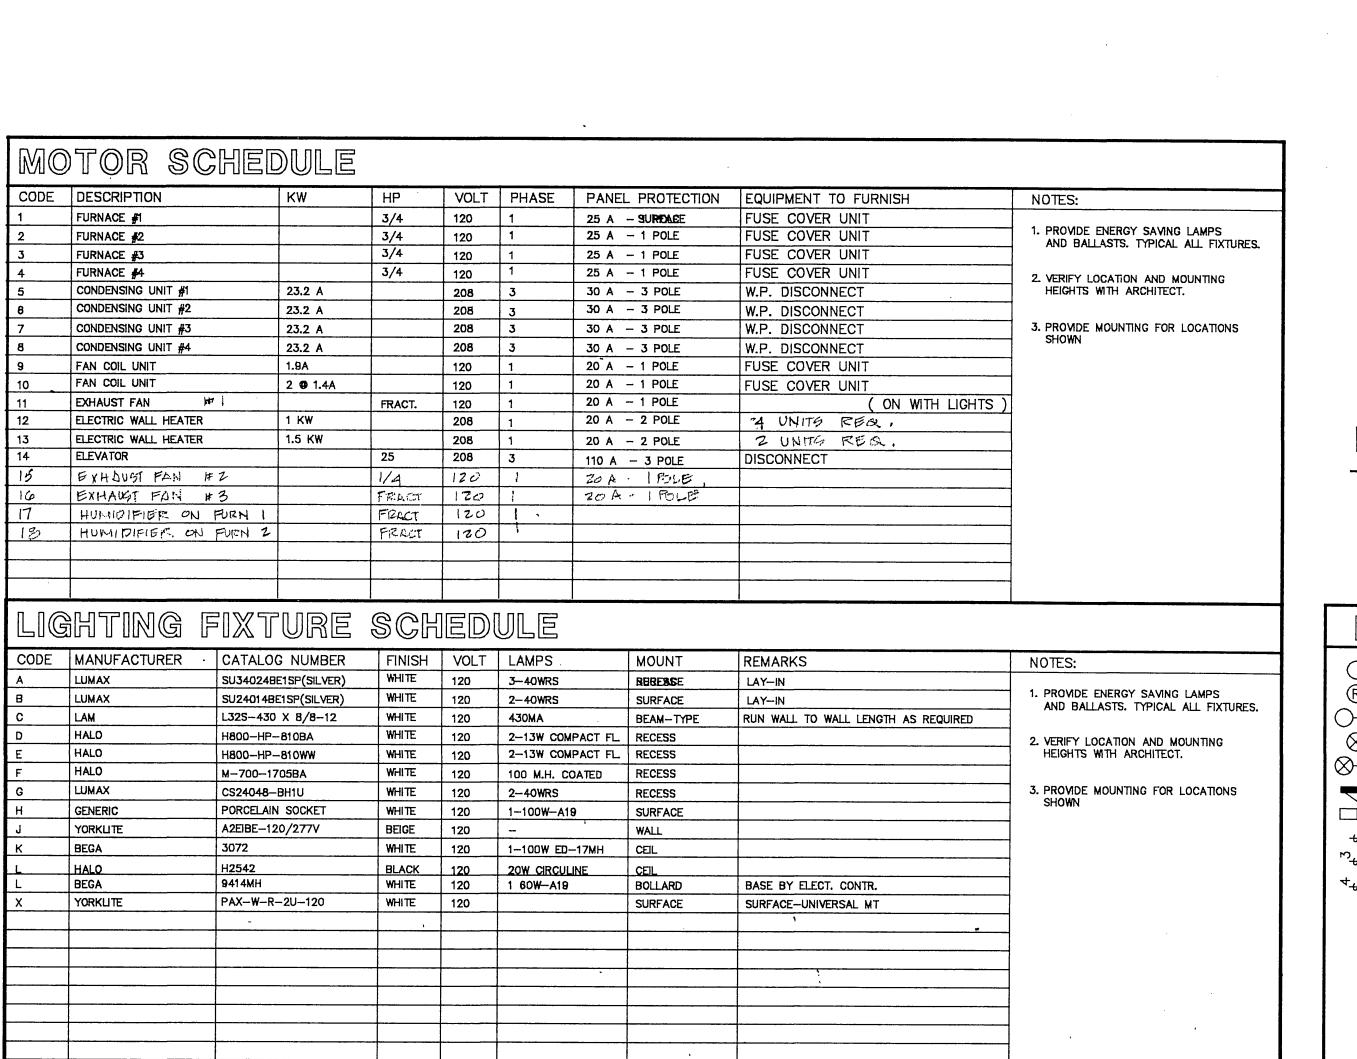

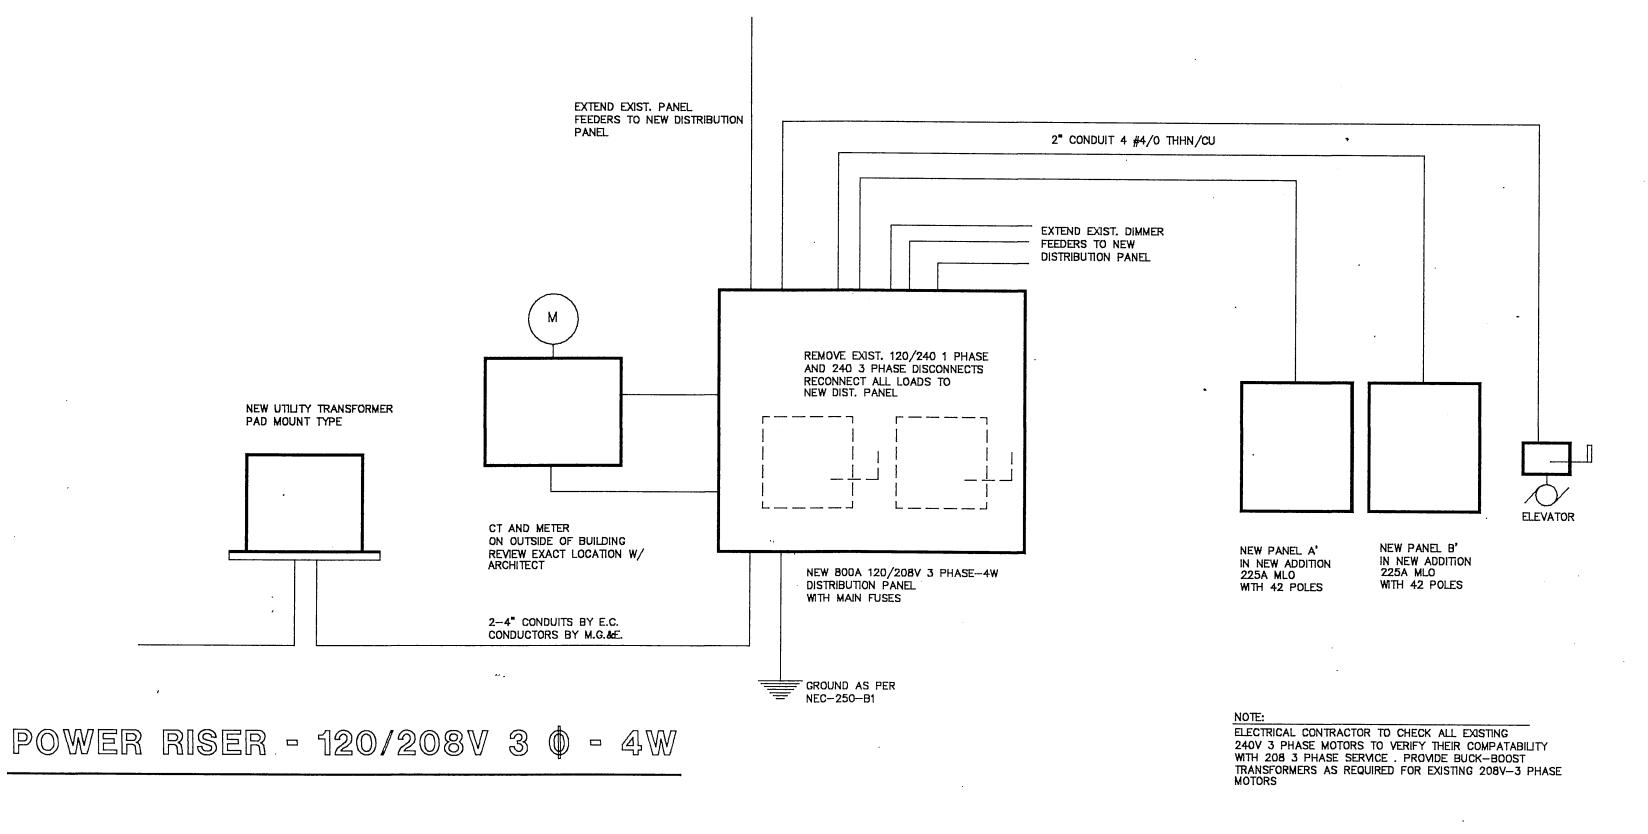



REVISIONS

PDG JOB NO.

9029

